


KEYSTONE CLADDING -8" \$ 12" HIGH CAST IN RANDOM ASHLAR PATTERN North Bay Island

(ON BOTH SIDES OF WALL) LETTERING 12" UPPERCASE \$ 8" LOWERCASE CAST Treasure: Island BRONZE LETTER CHANNEL LETTERS TIMES NEW ROMAN FONT STUD MOUNTED USIOB FINISH

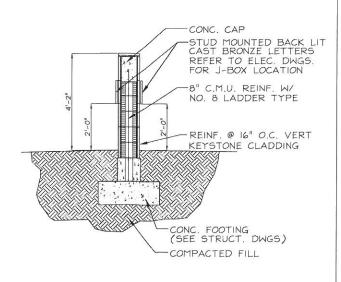

2 ENTRANCE SIGN ELEVATIONS SCALE: 1/2* - 1'-0*

3 SCALE: 1/2" - 1'-0"

ENTRANCE SIGNS

REVISIONS		APPROVED BY:
DESCRIPTION	DATE	
1. FDOT COMMENTS 2. 3. 4.	04/09/10	JAVIER F. SALMAN, AIA ARCHITECT REGISTRATION NO. 014410 STATE OF FLORIDA DATE:



CORZO CASTELLA CARBALLO THOMPSON SALMAN, P.A. | DRAWN: ENGINEERS ARCHITECTS PLANNERS
901 PONCE DE LEON BLVD.. SUITE 900
CORAL GABLES. FLORIDA 33134
MAMI (305)-448-9290 FLORIDA (800)-448-0227
FL REGISTRATIONS: EB0005022 AAC002142
CADD FILE:


CADD FILE:


JS JFS ECFS 1344-001


CITY OF NORTH BAY VILLAGE

JF KENNEDY CAUSEWAY (79 STREET CAUSEWAY) IMPROVEMENTS PHASE I

SHEET NO. A5

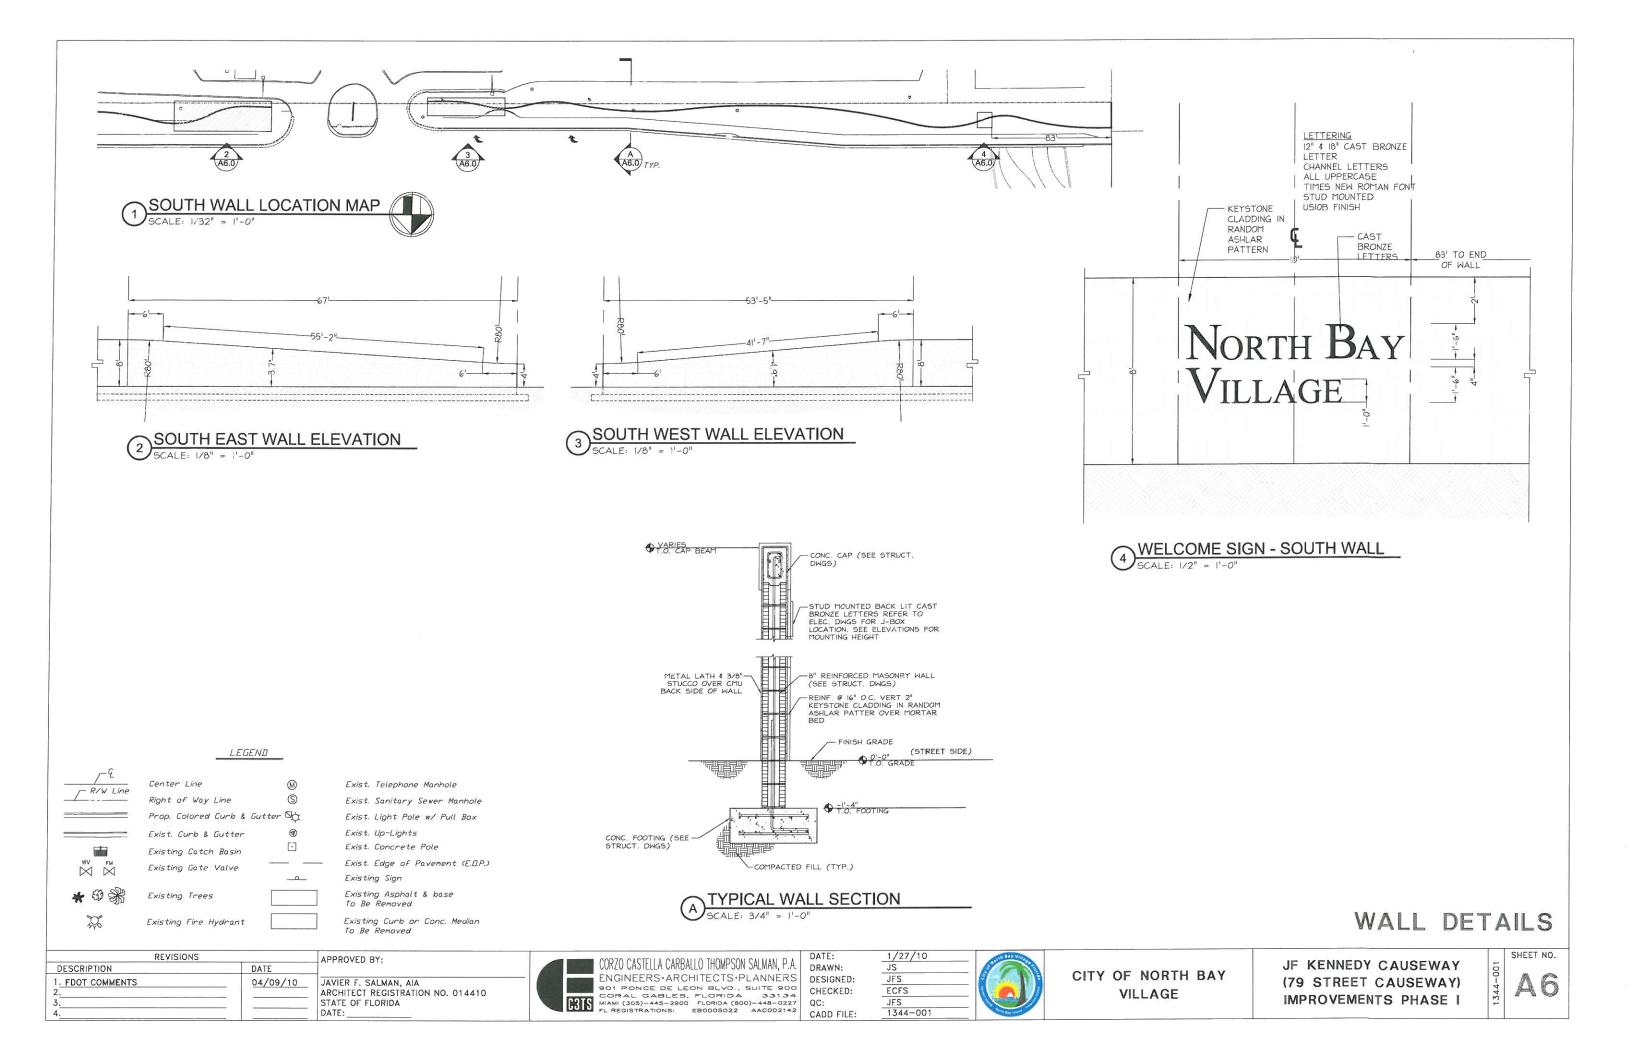

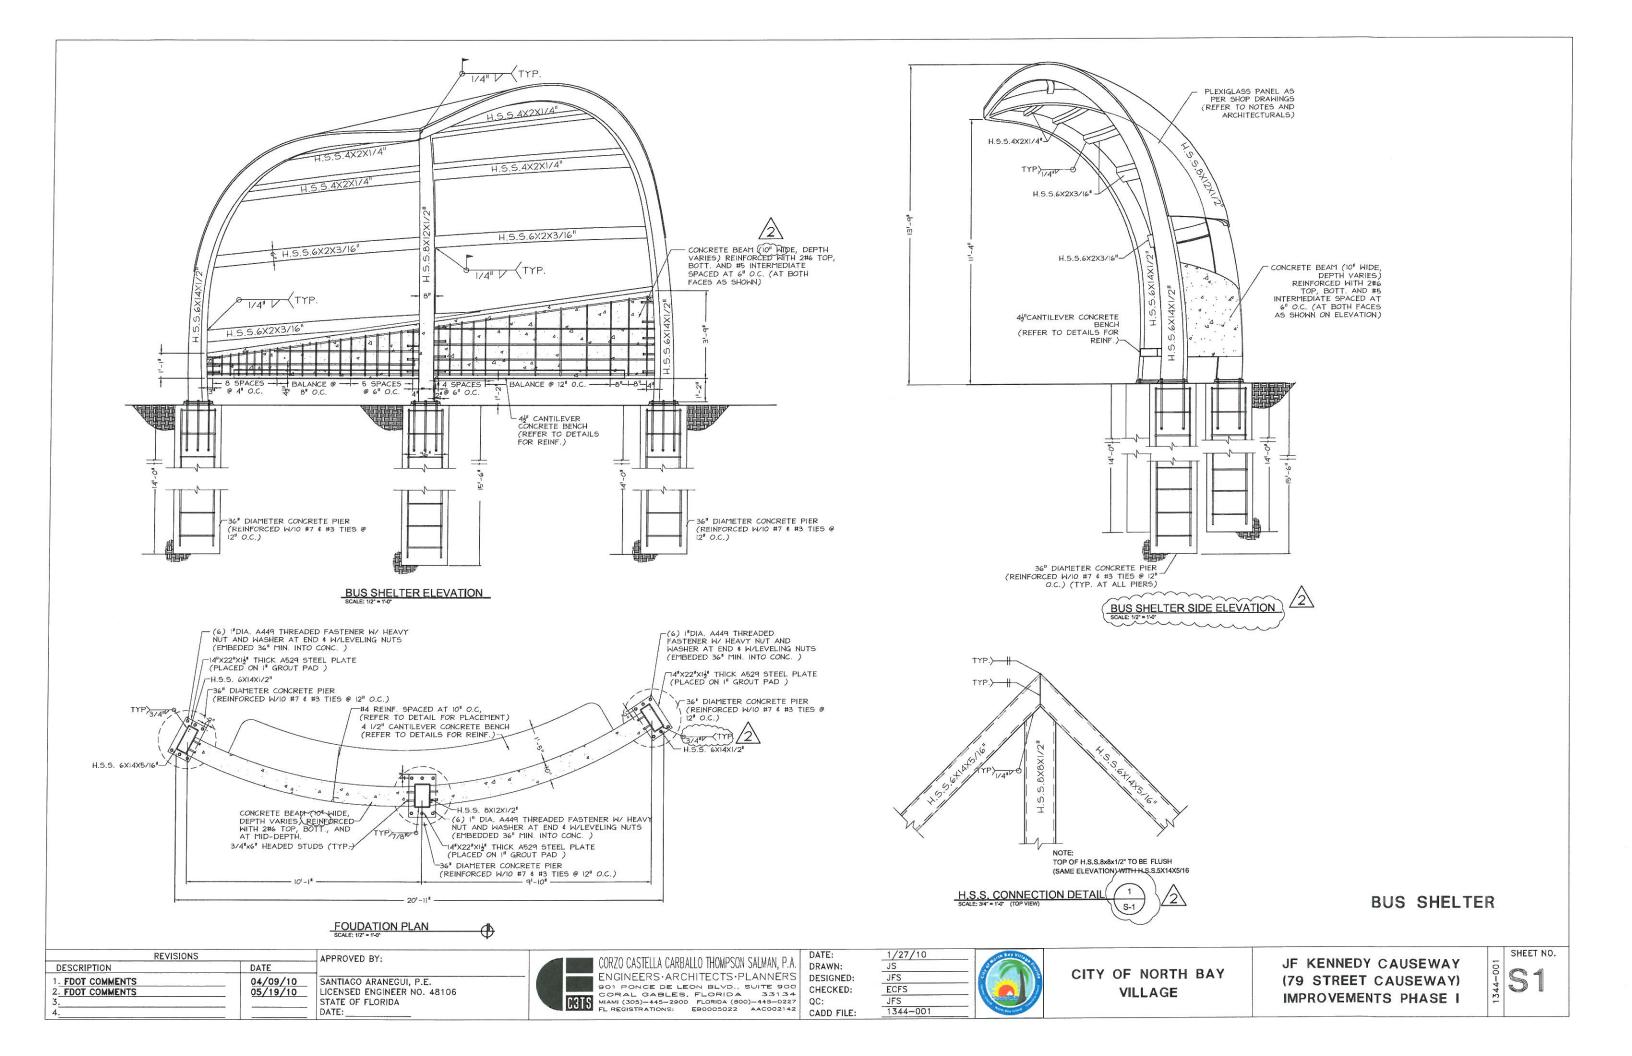

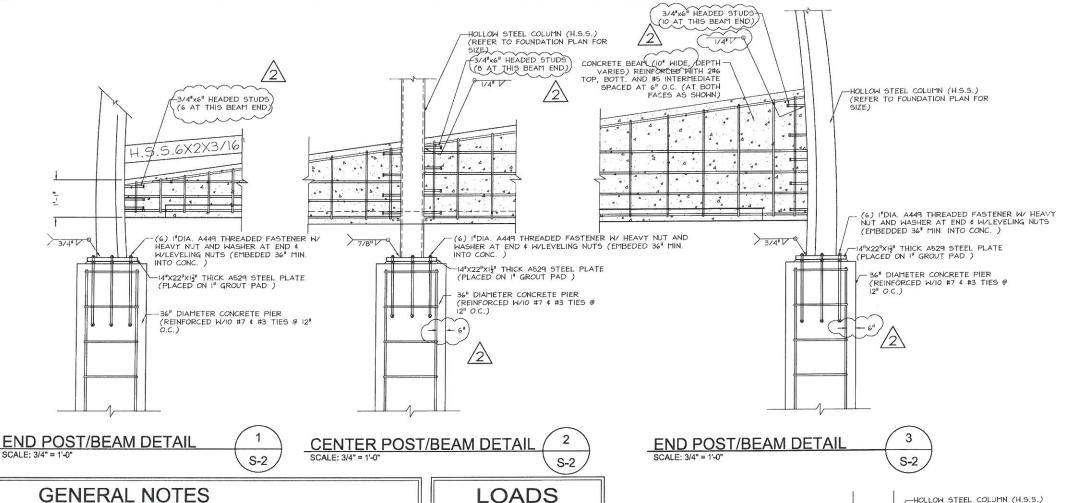

- . ALL CONSTRUCTION SHALL COMPLY WITH THE PERTINENT SECTIONS OF THE 2007 FLORIDA BUILDING CODE.
- 2. CONTRACTOR TO VERIFY ALL DIMENSIONS PRIOR TO CONSTRUCTION. ANY DISCREPANCIES SHALL BE REPORTED TO THE ENGINEER/ARCHITECT BEFORE PROCEEDING.
- 3. CONTRACTOR SHALL SUBMIT SHOP DRAWINGS. APPROVAL OF SHOP DRAWINGS BY THE ENGINEER/ARCHITECT IS FOR DESIGN AND LAYOUT ONLY, AND IS NOT FOR THE PURPOSE OF AUTHORIZING CHANGES TO THE CONTRACT DRAWINGS FOR APPROVING SUBSTITUTIONS.
- 4. ALL ELEVATIONS SHOWN ON THESE DRAWINGS ARE MEASURED WITH RESPECT TO THE FINISH FLOOR. +0'-0"
- 5. ALL STRUCTURAL STEEL SHALL CONFORM TO ASTM A529 (FY=42 KSI), UNLESS OTHERWISE NOTED.
- 6. ALL STRUCTURAL TUBING SHALL CONFORM TO ASTM A50 GRADE B (FY-46 KSI).
- . ALL BOLTING SHALL BE PERFORMED WITH HIGH STRENGTH BOLTS INCLUDING SUITABLE NUTS AND PLAIN HARDENED WASHERS
- 8. ALL WELDS TO BE PERFORMED WITH ETOXX ELECTRODES AND IN ACCORDANCE WITH AWS.
- 9. ALL REINFORCING BARS SHALL BE GRADE 60 CONFORMING TO ASTM A615
- 10. ALL CONCRETE CONSTRUCTION SHALL COMPLY WITH ACI 318. ALL CONCRETE USED SHALL HAVE A 28 DAY MINIMUM COMPRESSIVE STRENGTH OF 3000 P.S.I. AND A MAXIMUM SLUMP OF 6".
- II. MINIMUM CONCRETE COVER FOR REINFORCEMENT SHALL BE PROVIDED IN ACCORDANCE WITH ACI 318 SECTION 7.7.1.
- 12. GROUT FOR FOR BASEPLAE GROUTING SHALL BE NON-SHRINK GROUT AND SHALL HAVE A MINIMUM/COMPRESSIVE STRENGTH OF 4000 P.S.I.
- 13. ALL STEEL SHALL BE FINISHED WITH A CORROSION INHIBITING COATING, INCLUDING FIELD WELDS TREFER TO ARCHITECTURAL SPECIFICATIONS FOR FINISH).

SPECIALTY NOTES

THE PLEXIGLASS CLADDING SHALL BE DESIGNED AND FABRICATED TO CONFORM TO ASCE 7-05 WIND LOADS. SHOP DRAWINGS SHALL BE PROVIDED DETAILING THE PANEL SHAPES AND ATTACHMENTS TO THE STEEL FRAMING. THE PANELS SHALL BE DESIGNED BY A PROFESSIONAL ENGINEER REGISTERED IN THE STATE OF FLORIDA.


FABRICATION NOTES

THE BUS SHELTER FRAMING SHALL BE FRABICATED IN ACCORDANCE WITH THE ARCHITECTURAL DRAWINGS. REFER TO THE ARCHITECURAL DRAWINGS FOR DIMENSIONS AND STEEL FRAMING GEOMETY, THE CONTRACTOR SHALL NOTIFY THE ARCHITECT OR ENGINEER OR RECORD IF ANY DISCREPANCIES ARE OBSERVED.

DESIGN CRITERIA: FBC 2007 WIND LOADS: ASCE 7-05 CAT. II - EXP. C - V= 146 MPH - 1=1.00

SOIL STATEMENT

THE CONCRETE PIER FOUNDATIONS HAVE BEEN DESIGNED FOR A SOIL POSSESING A 30 DEGREE ANGLE OF FRICTION, A DENSITY OF 110 PCF, CONSISTENT WITH A SOIL HAVING AN ALLOWABLE BEARING CAPACITY OF 2000 PSF, TO BE VERIFIED BY GEOTECHNICAL ANALYSIS

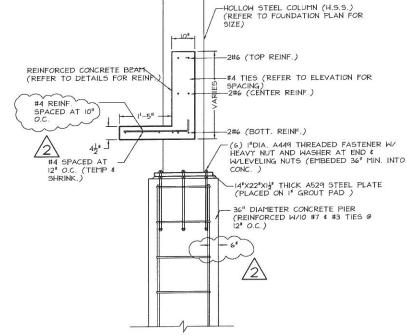

TYP. POST/BEAM SECTION

S-2

BUS SHELTER DETAILS

REVISIONS APPROVED BY: DESCRIPTION DATE 04/09/10 FDOT COMMENTS SANTIAGO ARANEGUI, P.E. 2. FDOT COMMENTS 05/19/10 LICENSED ENGINEER NO. 48106 STATE OF FLORIDA DATE:



CORZO CASTELLA CARBALLO THOMPSON SALMAN, P.A. ENGINEERS ARCHITECTS PLANNERS 901 PONCE DE LEON BLVD., SUITE 900 CORAL GABLES, FLORIDA MIAMI (305)-445-2900 FLORIDA (800)-448-0227 FL REGISTRATIONS: EB0005022 AAC002142

DATE:	
DRAWN:	
DESIGNED:	
CHECKED:	
QC:	
CADD FILE.	

1/27/10	FIR BOY V
JS	Stroth
JFS	
ECFS	
JFS	1
1344-001	The same of

CITY OF NORTH BAY VILLAGE

JF KENNEDY CAUSEWAY (79 STREET CAUSEWAY) IMPROVEMENTS PHASE I

SHEET NO. 52

GENERAL NOTES

- I. ALL CONSTRUCTION SHALL COMPLY WITH THE PERTINENT SECTIONS OF THE 2007 FLORIDA BUILDING CODE
- 2. CONTRACTOR TO VERIFY ALL DIMENSIONS PRIOR TO CONSTRUCTION. ANY DISCREPANCIES SHALL BE REPORTED TO THE ENGINEER/ARCHITECT BEFORE PROCEEDING.
- 3. CONTRACTOR SHALL SUBMIT SHOP DRAWINGS. APPROVAL OF SHOP DRAWINGS BY THE ENGINEER/ARCHITECT IS FOR DESIGN AND LAYOUT ONLY, AND IS NOT FOR THE PURPOSE OF AUTHORIZING CHANGES TO THE CONTRACT DRAWINGS FOR APPROVING SUBSTITUTIONS
- 4. ALL ELEVATIONS SHOWN ON THESE DRAWINGS ARE MEASURED WITH RESPECT TO THE FINISH FLOOR. +0'-0*.
- 5. ALL REINFORCING BARS SHALL BE GRADE 60 CONFORMING TO ASTM A615.
- 6, ALL CONCRETE CONSTRUCTION SHALL COMPLY WITH ACI 318, ALL CONCRETE USED SHALL HAVE A 28 DAY MINIMUM COMPRESSIVE STRENGTH OF 3000 P.S.I. AND A MAXIMUM SLUMP OF 6° .
- 7. MASONRY CONSTRUCTION SHALL COMPLY WITH THE BUILDING CODE AND SPECIFICATIONS FOR CONCRETE MASONRY STRUCTURES ACI 530 AND ACI 530.1.
- 8. CONCRETE MASONRY SHALL HAVE A NET AREA COMPRESSIVE STRENGTH f'm=2000 P.S.I. FOR THE 8'-0 WALL AND f'm=1500 FOR THE LOWER WALLS AND SHALL COMPLY WITH ASTM C90. CONCRETE MASONRY UNITS SHALL HAVE A MINIMUM NET AREA COMPRESSIVE STRENGTH OF 2800 P.S.I. AND 1900 PSI RESPECTIVELY.
- 9. MASONRY MORTAR SHALL BE TYPE M OR S AND SHALL COMPLY WITH ASTM C270.
- 10. GROUT FOR GROUTING CELLS SHALL HAVE A MINIMUM COMPRESSIVE STRENGTH OF 2000 P.S.I. OR THE BLOCK STRENGTH, WHICH EVER IS GREATER AND SHALL BE IN ACCORDANCE WITH WITH ASTM C476-91. GROUT TO HAVE A SLUMP BETWEEN 8" TO 11".
- II. A SPECIAL INSPECTOR, RETAINED BY THE OWNER, SHALL INSPECT AND SUPERVISE THE CONSTRUCTION OF REINFORCED MASONRY PER ACL 530.1


LOADS


DESIGN CRITERIA: FBC 2007

WIND LOADS: ASCE 7-05 CAT. II - EXP. C - V= 146 MPH - 1=1.00

SOIL STATEMENT

THE FENCE WALL FOUNDATIONS HAVE BEEN DESIGNED FOR A SOIL POSSESING AN ALLOWABLE BEARING CAPACITY OF 2000 PSF, TO BE VERIFIED BY GEOTECHNICAL ANALYSIS.

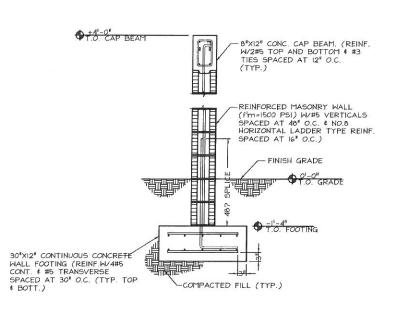

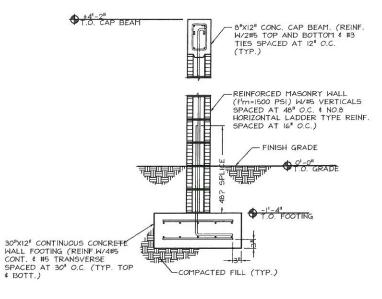




SCALE: 3/4" = 1'-0"

<u>2</u> S-1 MASONRY MONUMENT SIGN
WALL SECTION

SCALE: 3/4" = 1'-0"

 $-\left(\frac{3}{\text{S-1}}\right)$

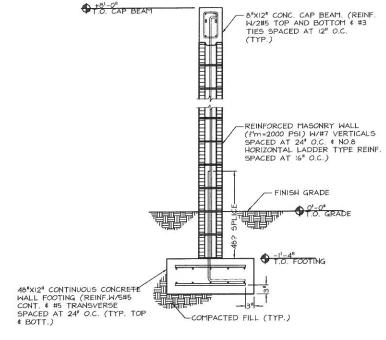

TYP. 8'-0" HIGH MASONRY FENCE SECTION SCALE: 3/4" = 1'-0"

1 S-1 MASONRY WALL

REVISIONS		APPROVED BY:
DESCRIPTION	DATE	ATTROVES BY:
1. FDOT COMMENTS 2. FDOT COMMENTS	04/09/10 05/19/10	SANTIAGO ARANEGUI, P.E. LICENSED ENGINEER NO. 48106
3. 4.		STATE OF FLORIDA DATE:



CORZO CASTELLA CARBALLO THOMPSON SALMAN, P.A.
ENGINEERS · ARCHITECTS · PLANNERS
901 PONCE DE LEON BLVD., SUITE 900
CORAL GABLES, FLORIDA 33134
MAMI (305)-445-2900 FLORIDA (800)-448-0227
FL REGISTRATIONS: EB0005022 AAC002142

1	DATE:
-	DRAWN:
	DESIGNED:
1	CHECKED:
	QC:
1	CADD FILE:


JFS

ECFS

JFS 1344-00



CITY OF NORTH BAY VILLAGE JF KENNEDY CAUSEWAY (79 STREET CAUSEWAY) IMPROVEMENTS PHASE I 24-001 SHEET NO.

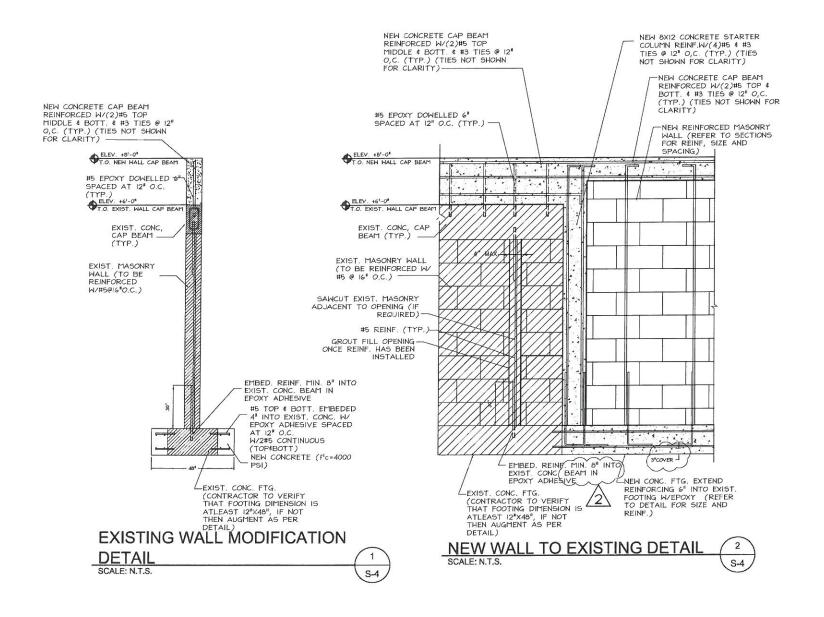

EXISTING WALL DETAIL

REVISIONS		APPROVED BY:	
DESCRIPTION	DATE		
1. FDOT COMMENTS	04/09/10	SANTIAGO ARANEGUI, P.E.	
2. FDOT COMMENTS	05/19/10	LICENSED ENGINEER NO. 48106	
3.		STATE OF FLORIDA	
4.		DATE:	



CORZO CASTELLA CARBALLO THOMPSON SALMAN, P.A. ENGINEERS · ARCHITECTS · PLANNERS 901 PONCE DE LEON BLVD., SUITE 900
CORAL GABLES, FLORIDA 33134
MIAMI (305)-445-2900 FLORIDA (800)-448-0227
FL REGISTRATIONS: EB0005022 AAC002142

T	DATE:
1	DRAWN:
	DESIGNED:
1	CHECKED:
	QC:
П	CARD FUE

1/27/10

JS

JFS

ECFS

JFS 1344-001

	Status toy Village
-	
-	
-	The same of the sa

CITY OF NORTH BAY VILLAGE

JF KENNEDY CAUSEWAY (79 STREET CAUSEWAY) IMPROVEMENTS PHASE I

SHEET NO. 54