

## **LEGEND:**

### PLAN SYMBOLS

ELECTRIC A.C. MOTOR, NO. INDICATES HORSEPOWER.

CONDUIT RUN EXPOSED. RUN PARALLEL OR PERPENDICULAR TO STRUCTURE OR WALL.

CONDUIT CONCEALED IN OR BELOW FLOOR OR UNDERGROUND.

HOME RUN TO PANELBOARD. NUMBER OF ARROWS INDICATE NUMBER OF CIRCUITS. HASH MARKS INDICATE NUMBER OF #12 AWG. CONDUCTORS. NO HASH MARKS INDICATE 2 #12 CONDUCTORS.

LEVEL TRANSDUCER

LIQUID LEVEL SWITCH

TEMPERATURE SWITCH

SEAL FAIL

GROUND ROD

GROUND TEST WELL

#### <u>ABBREVIATIONS</u>

ABOVE FINISHED GRADE CONTROL PANEL CONTROL POWER TRANSFORMER FLORIDA POWER & LIGHT FULL VOLTAGE NON-REVERSING GROUND HORSEPOWER LEVEL INDICATING TRANSMITTER

MANUFACTURER SUPPLIED CABLE MTD MOUNTED

NATIONAL ELECTRICAL CODE NUMBER NTS NOT TO SCALE

PUMP STATION CONTROL PANEL SURGE PROTECTION DEVICE

STAINLESS STEEL SOLID STATE STARTER TYPICAL

VOLT AMPERES VARIABLE FREQUENCY DRIVE

**WEATHERPROOF** WITH PHASE

- 1. ELECTRICAL CONTRACTOR SHALL SUPPLY AND INSTALL ALL NEW ELECTRICAL WORK INDICATED.
- 2. ELECTRICAL CONTRACTOR SHALL VISIT JOB SITE AND FAMILIARIZE HIMSELF WITH ALL CONDITIONS AFFECTING ELECTRICAL INSTALLATION AND MAKE PROVISIONS AS TO THE COST THEREOF. EXISTING CONDITIONS OF ELECTRICAL EQUIPMENT, LIGHT FIXTURES, ETC... THAT ARE PART OF THE FINAL SYSTEM SHALL BE VERIFIED BY THE CONTRACTOR PRIOR TO SUBMITTING HIS BID.

ALL WORK SHALL BE DONE IN ACCORDANCE WITH THE 2014 NATIONAL ELECTRICAL CODE, 2020 FLORIDA BUILDING, 2020 NATIONAL FIRE PROTECTION ASSOCIATION, AND SHALL COMPLY WITH ALL LOCAL RULES AND ORDINANCES. ^^^^^

4. MINIMUM WIRE SIZE SHALL BE #12 A.W.G. FOR POWER CIRCUITS.

- 5. IT IS NOT THE INTENT OF THESE PLANS TO SHOW EVERY MINOR DETAIL OF CONSTRUCTION. THE CONTRACTOR IS EXPECTED TO FURNISH AND INSTALL ALL HEMS FOR A COMPLETE ELECTRICAL SYSTEM AND PROVIDE ALL REQUIREMENTS NECESSARY FOR THE EQUIPMENT TO BE PLACED IN PROPER WORKING ORDER.
- 6. ELECTRICAL SYSTEM SHALL BE COMPLETE AND EFFECTIVELY GROUNDED AS REQUIRED BY THE LATEST EDITION OF THE N.E.C. OR LOCAL CODES. ALL CONDUITS SHALL HAVE A BOND WIRE SIZED PER TABLE 250-122 OF THE NATIONAL ELECTRICAL CODE.
- 7. ALL MATERIALS SHALL BE NEW AND BEAR UNDERWRITERS' LABELS WHERE APPLICABLE.
- 8. ALL WORK SHALL BE PERFORMED BY A LICENSED ELECTRICAL CONTRACTOR IN A FIRST CLASS WORKMANLIKE MANNER. THE COMPLETED SYSTEM SHALL BE FULLY OPERATIVE AND ACCEPTED BY
- 9. CONTRACTOR SHALL GUARANTEE ALL MATERIALS AND WORKMANSHIP FREE FROM DEFECTS FOR A PERIOD OF NOT LESS THAN ONE YEAR FROM DATE OF ACCEPTANCE.
- 10. CORRECTION OF ANY DEFECTS SHALL BE COMPLETED WITHOUT ADDITIONAL CHARGE AND SHALL INCLUDE REPLACEMENT OR REPAIR OF ANY OTHER PHASE OF THE INSTALLATION WHICH MAY HAVE
- 11. THE ELECTRICAL INSTALLATION SHALL MEET ALL STANDARD REQUIREMENTS OF FPL.
- 12. CONTRACTOR SHALL BE RESPONSIBLE FOR ALL CUTTING AND PATCHING REQUIRED OF HIS WORK.
- 13. ELECTRICAL CONTRACTOR SHALL LABEL ALL PANELS W/ TYPE WRITTEN DIRECTORIES.
- 14. ALL ELECTRICAL WIRING SHALL BE THE RESPONSIBILITY OF THE ELECTRICAL CONTRACTOR.
- 15. DO NOT SCALE THE ELECTRICAL DRAWINGS. REFER TO THE MECHANICAL DRAWINGS & THE APPROVED MANUFACTURER'S SHOP DRAWINGS FOR THE EXACT LOCATION OF ALL EQUIPMENT.
- 16. SLANTED AND SHADED TEXT DENOTES EXISTING EQUIPMENT OR STRUCTURES. NON-SLANTED TEXT DENOTES NEW EQUIPMENT, STRUCTURES & WORK.
- 17. ALL CONTROL PANELS SHALL BE UL LISTED AND MEET THE REQUIREMENTS OF ARTICLE 409 OF THE NATIONAL ELECTRICAL CODE.

10620 GRIFFIN ROAD, SUITE 202 COOPER CITY, FLORIDA 33328 PHONE: (954) 448-7930 C.O.A. NO. 6783 Stephen E. Bailey, P.E. Florida P.E. No. 42461





				Kimley»Horn
<u>∧</u> No.	ADDENDUM NO. 6  REVISIONS	03/09/22 DATE	SEB BY	600 NORTH PINE ISLAND ROAD, SUITE 450, PLANTATION, FL 33324 PHONE: 954-535-5100 FAX: 954-739-2247 WWW.KIMLEY-HORN.COM CA 00000696

KHA PROJECT 043138041 DATE MARCH 2022 SCALE AS SHOWN DESIGNED BY SEE

CHECKED BY SEB NORTH BAY VILLAGE

DRAWN BY

NORTH BAY VILLAGE MAIN PUMP STATION IMPROVEMENTS

PREPARED FOR NORTH BAY VILLAGE STEPHEN E. BAILEY, P.E. FLORIDA LICENSE NUMBER

42461


FLORIDA DATE: 3/9/22

LICENSED PROFESSIONAL

ELECTRICAL SITE PLAN, NOTES, SYMBOLS & ABBREVIATIONS

SHEET NUMBER

E-01

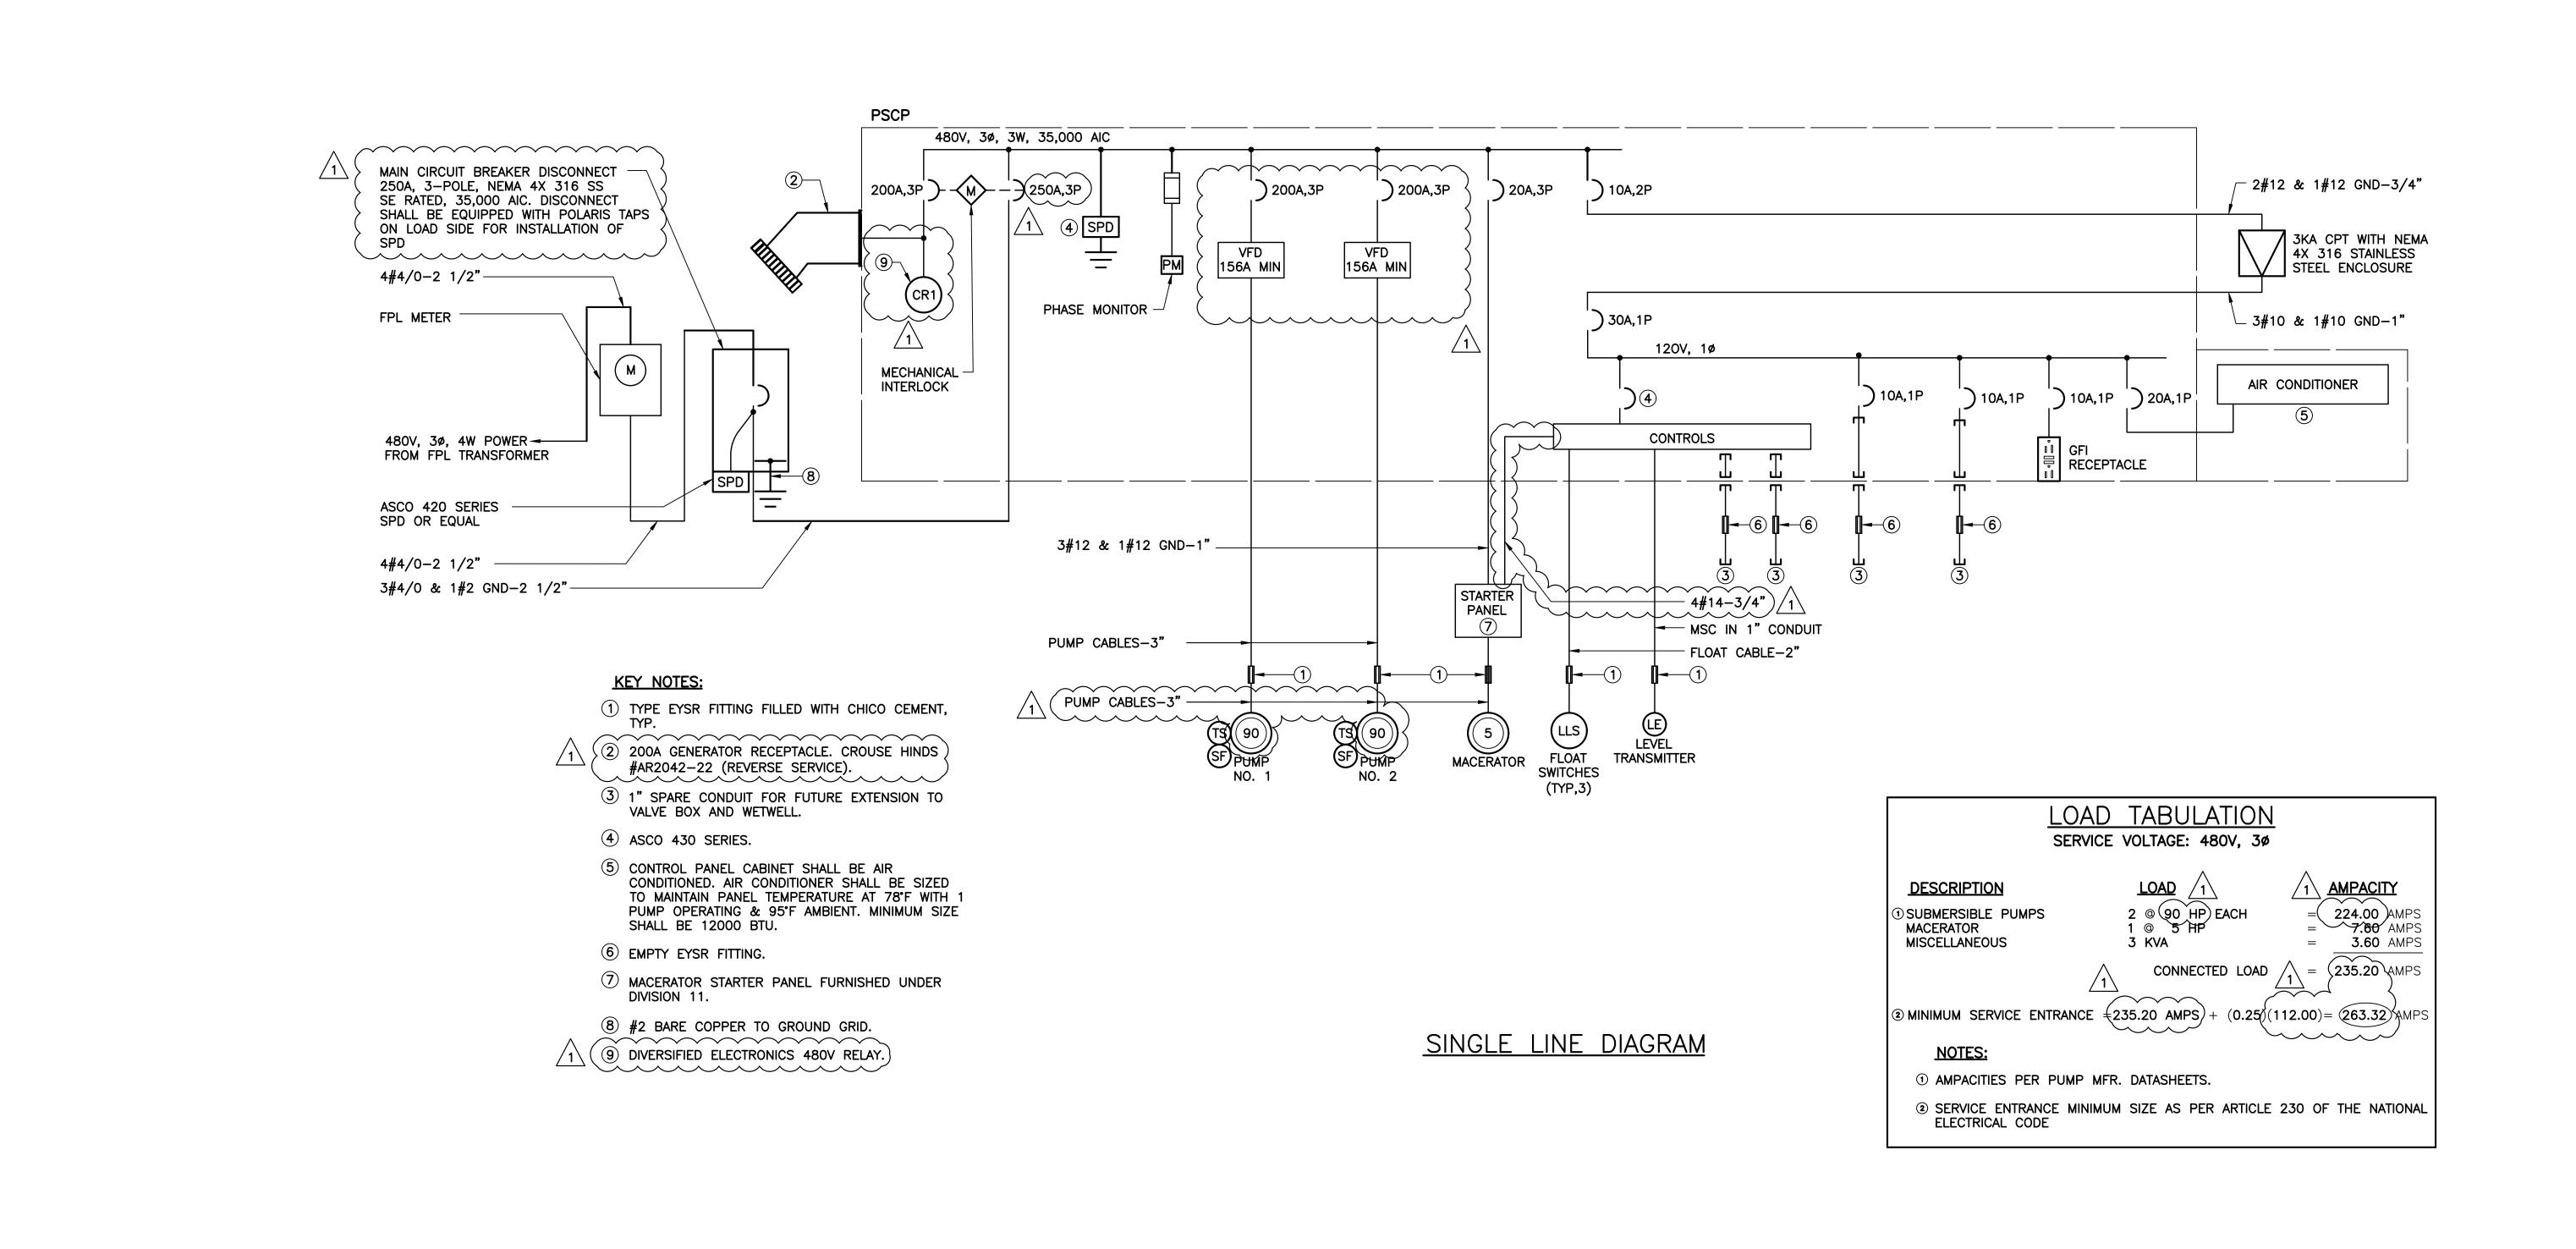

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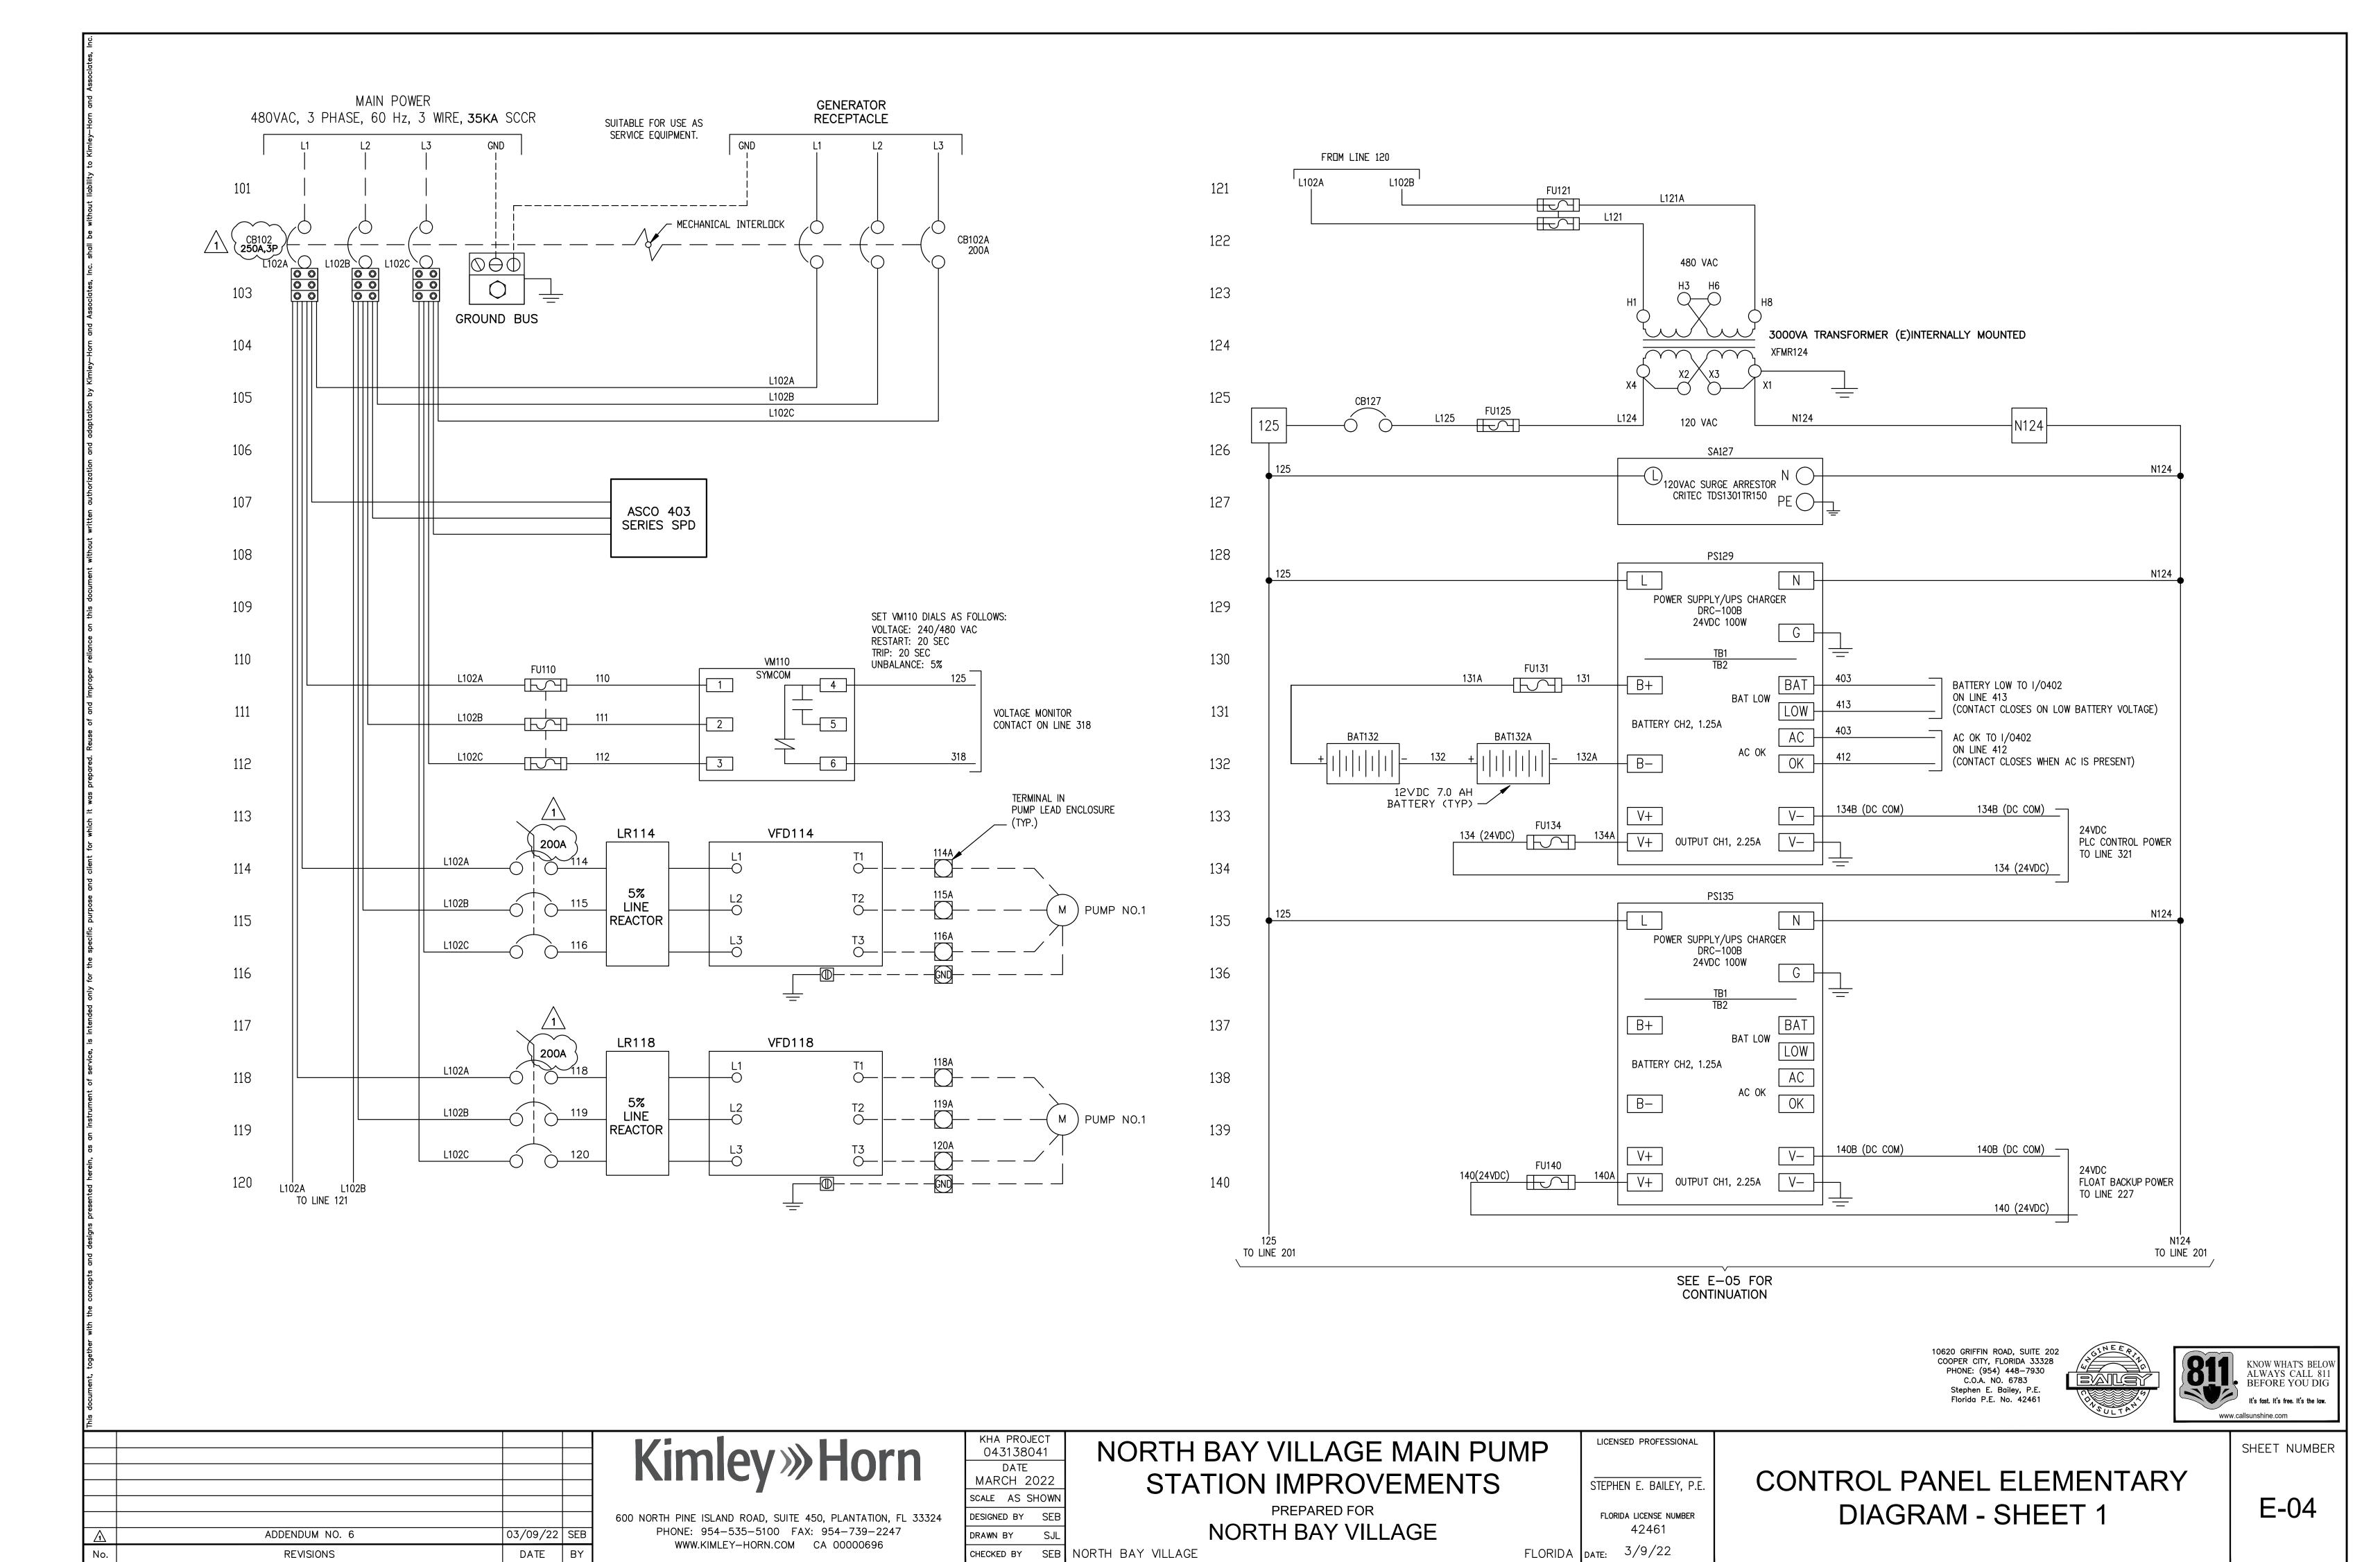
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SINGLE LINE DIAGRAM

SHEET NUMBER


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FLORIDA DATE: 3/9/22


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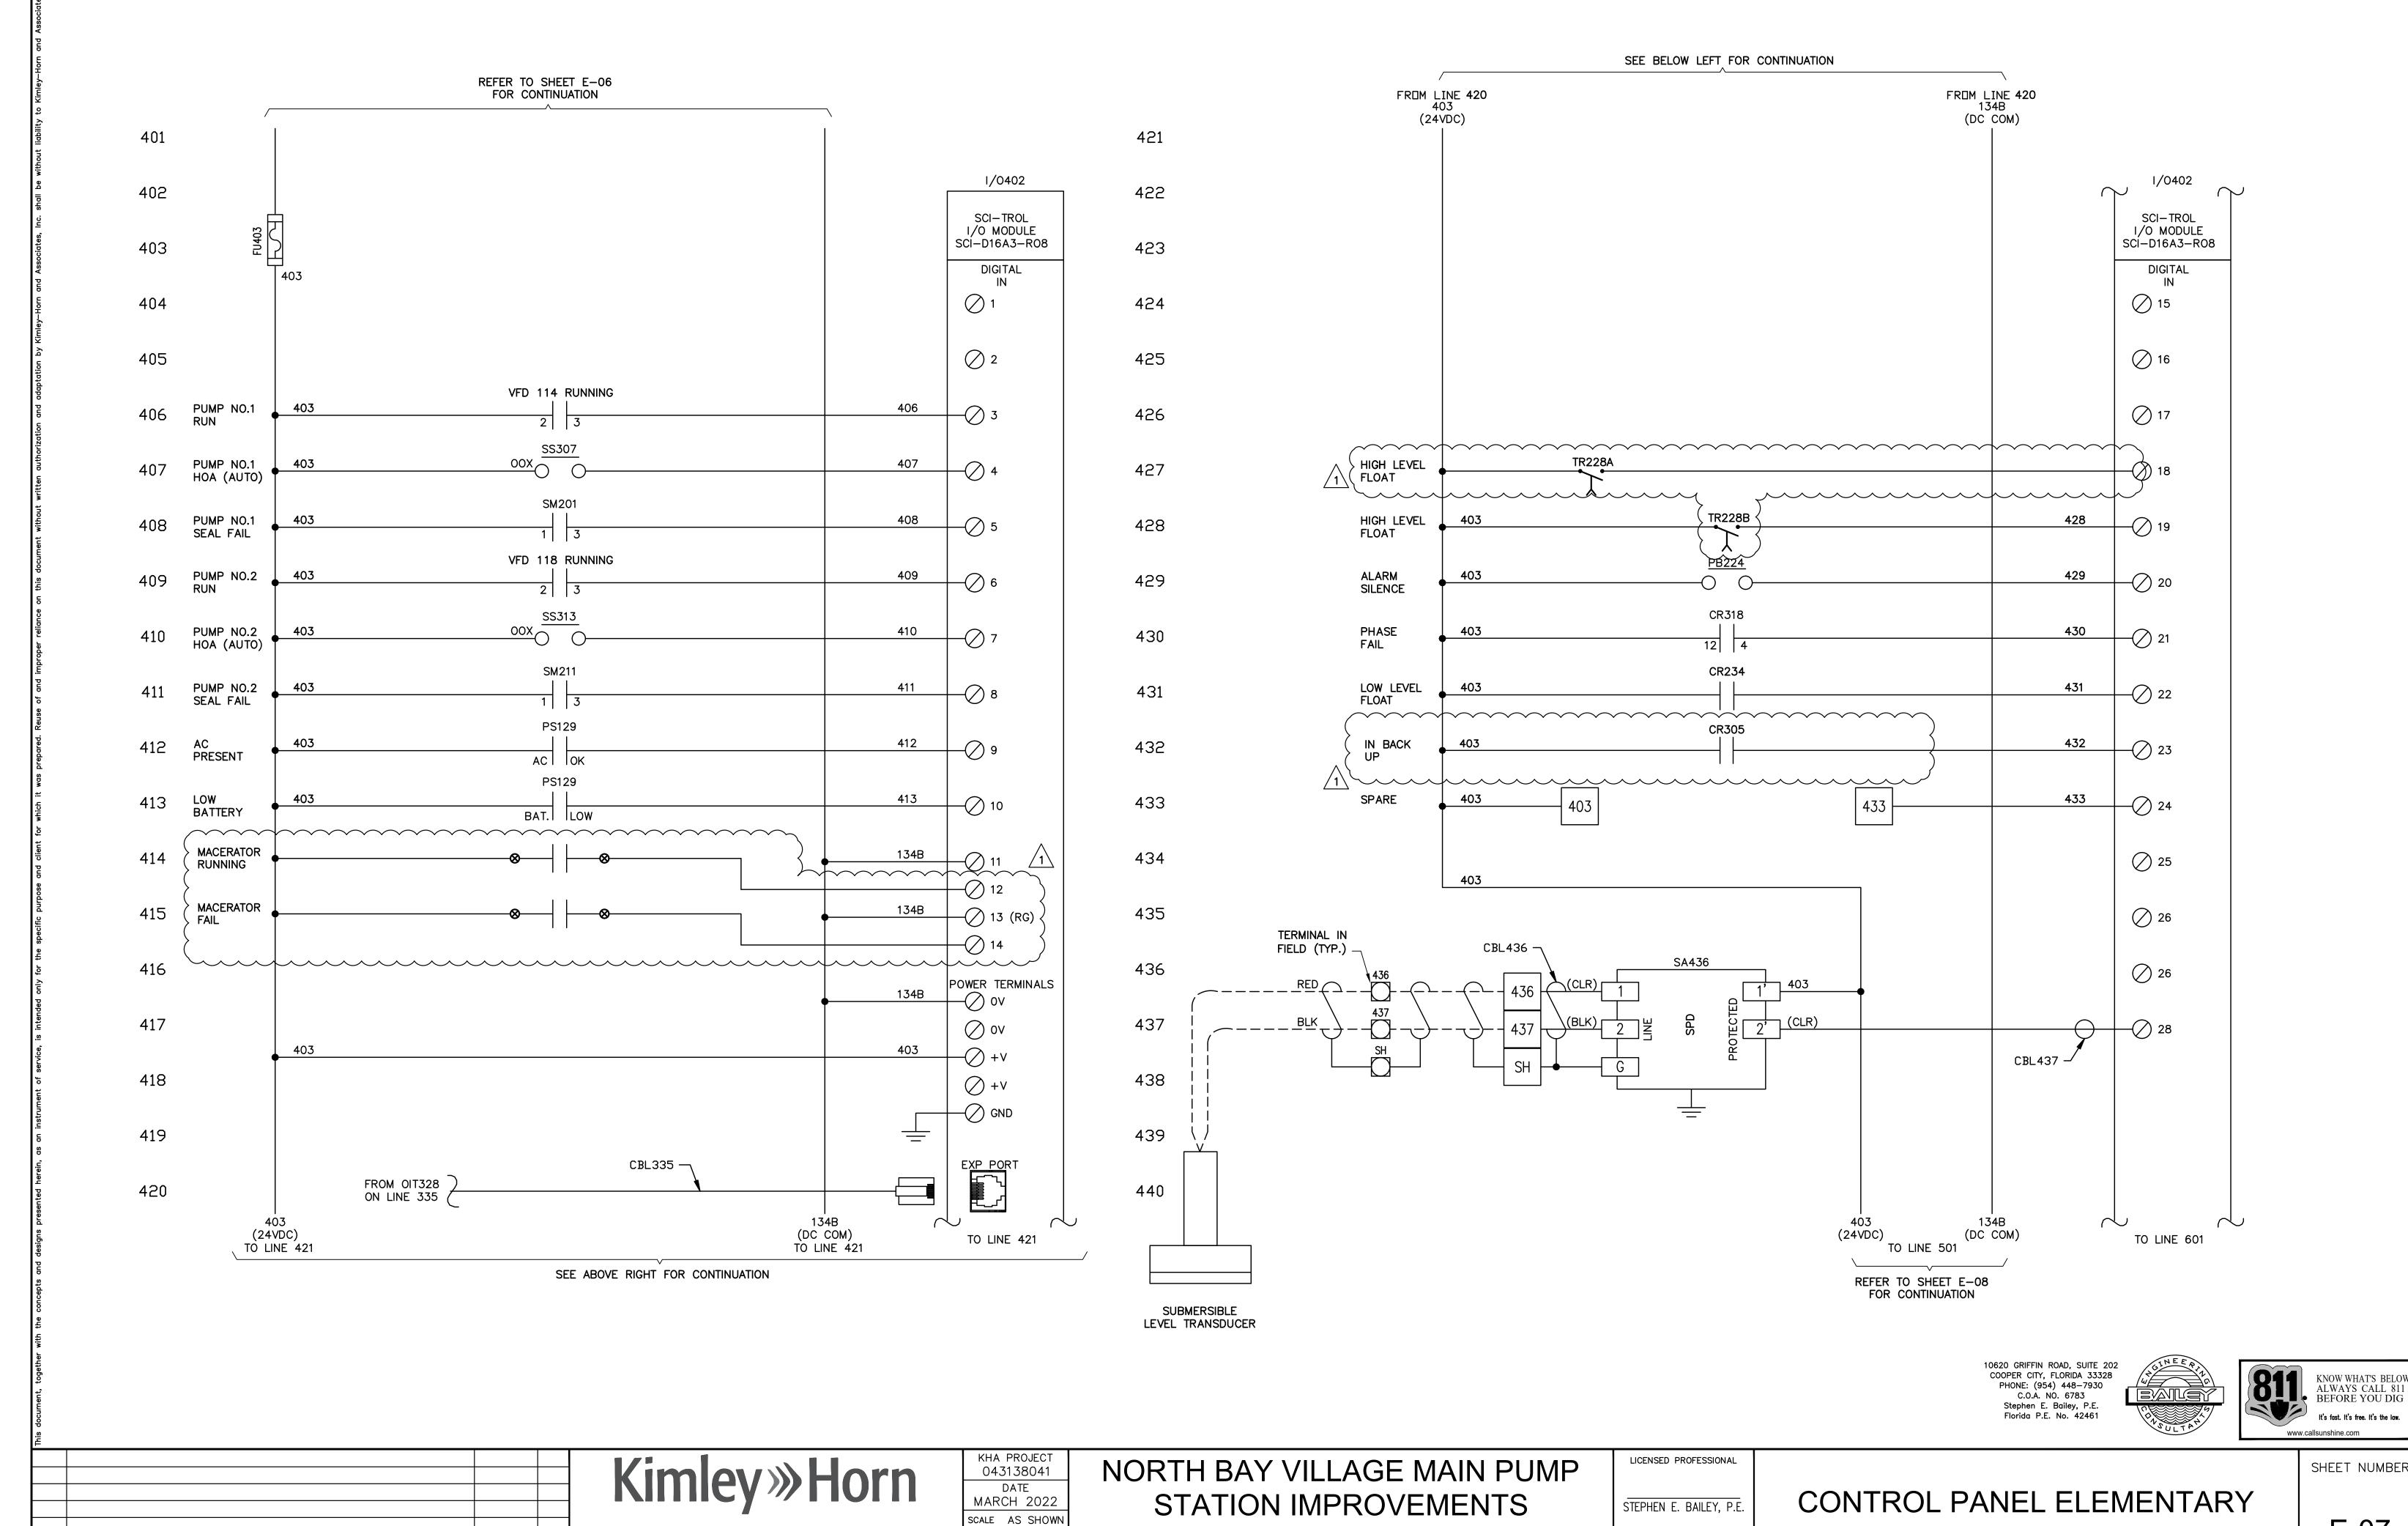
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PREPARED FOR

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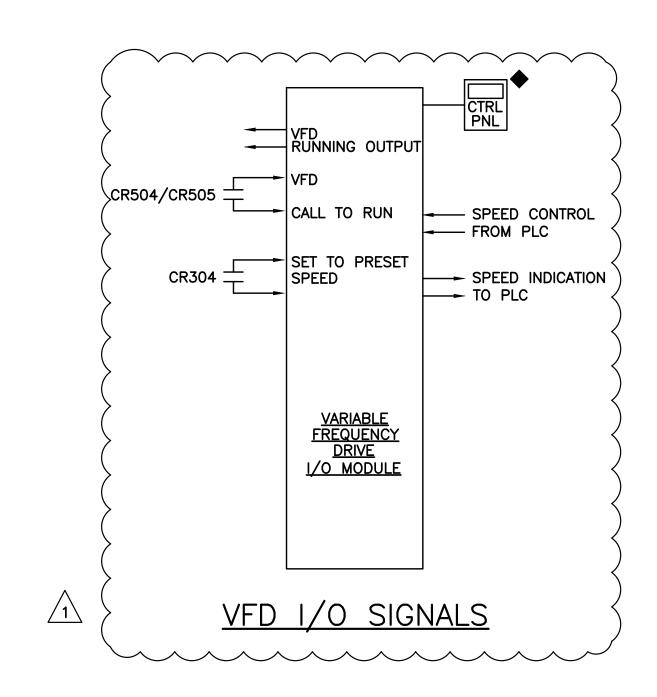
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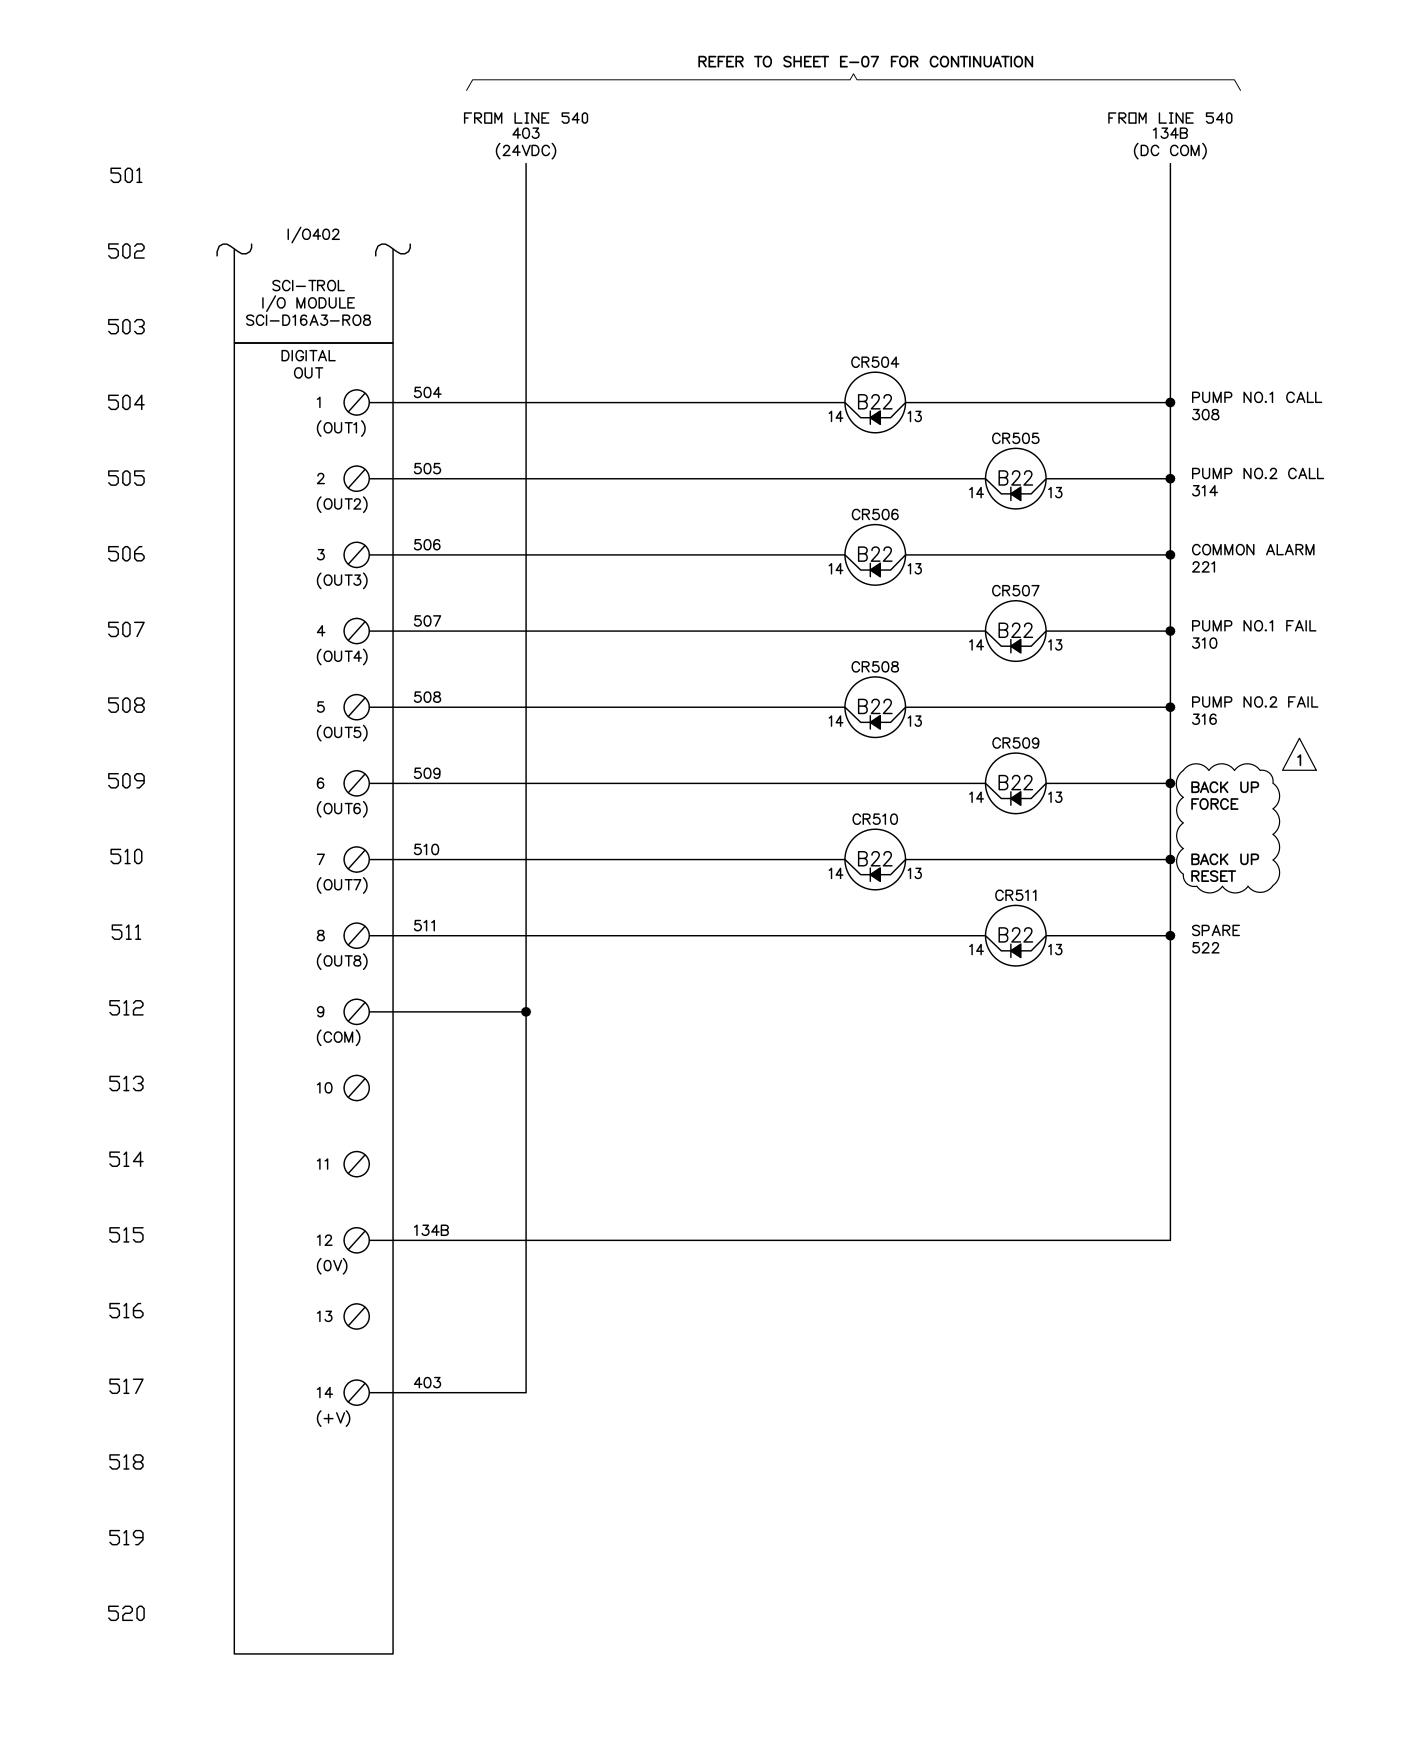
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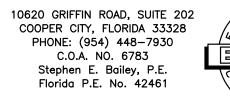
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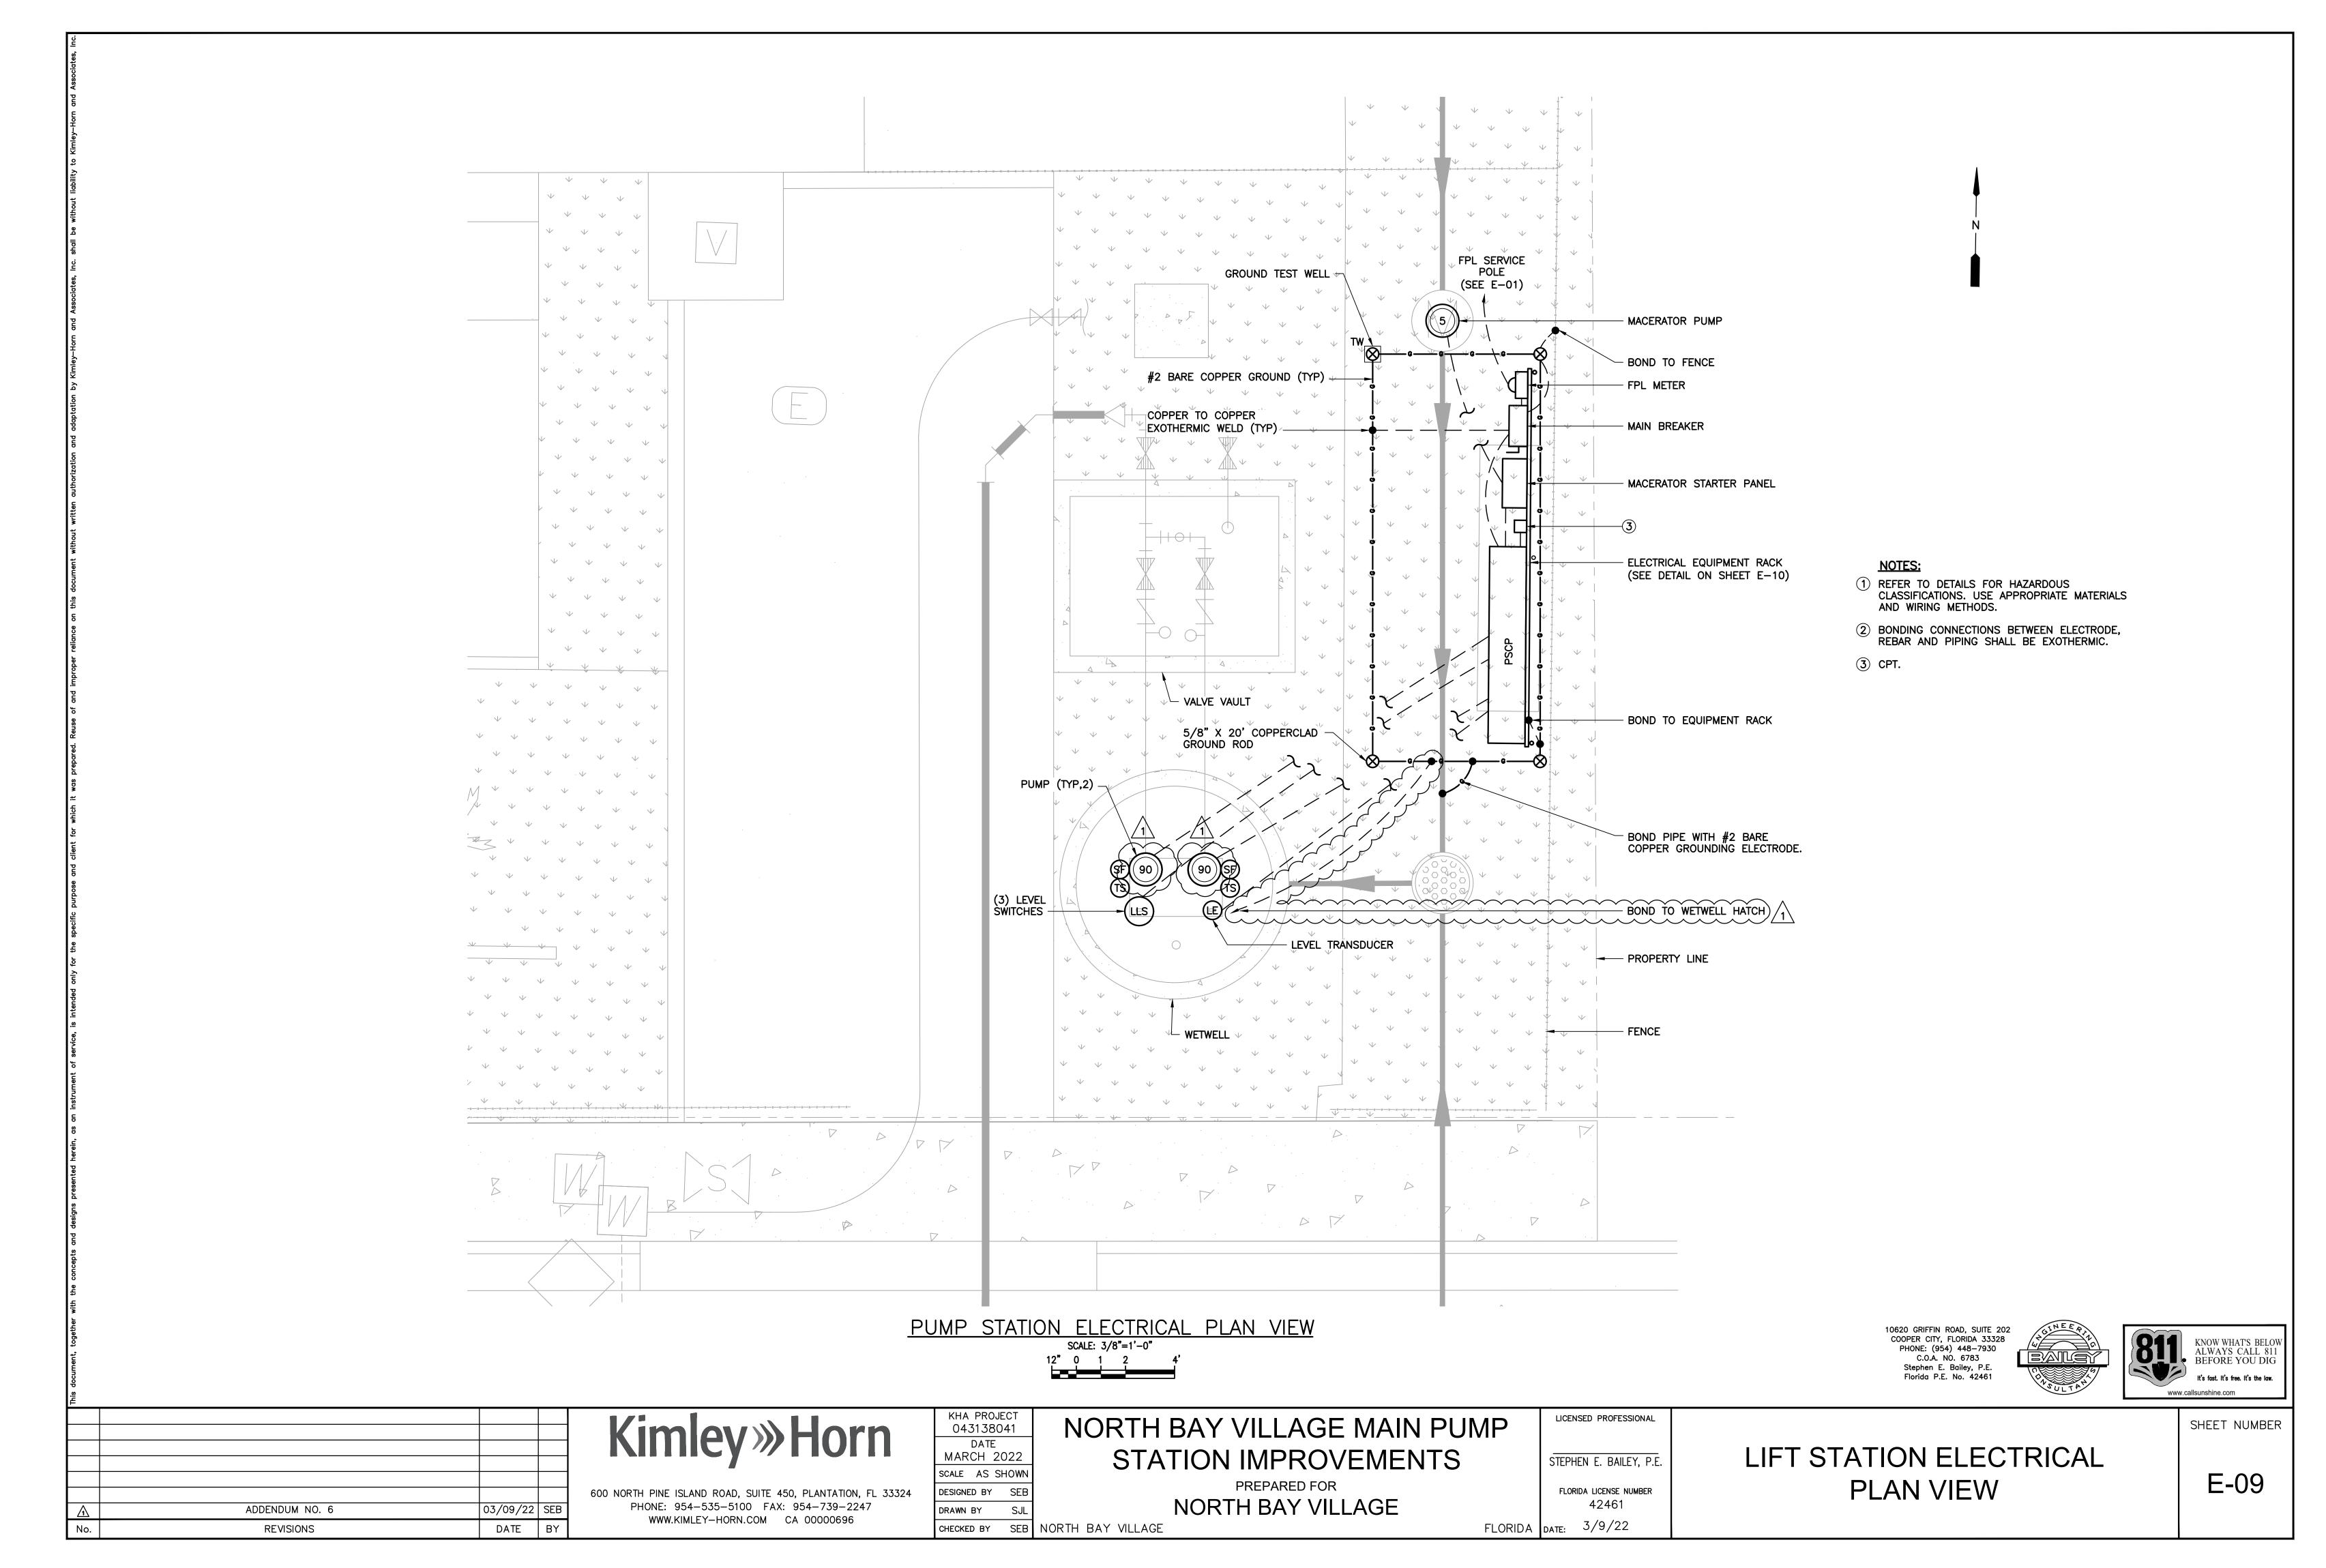
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LICENSED PROFESSIONAL

CONTROL PANEL ELEMENTARY
DIAGRAM - SHEET 5

SHEET NUMBER

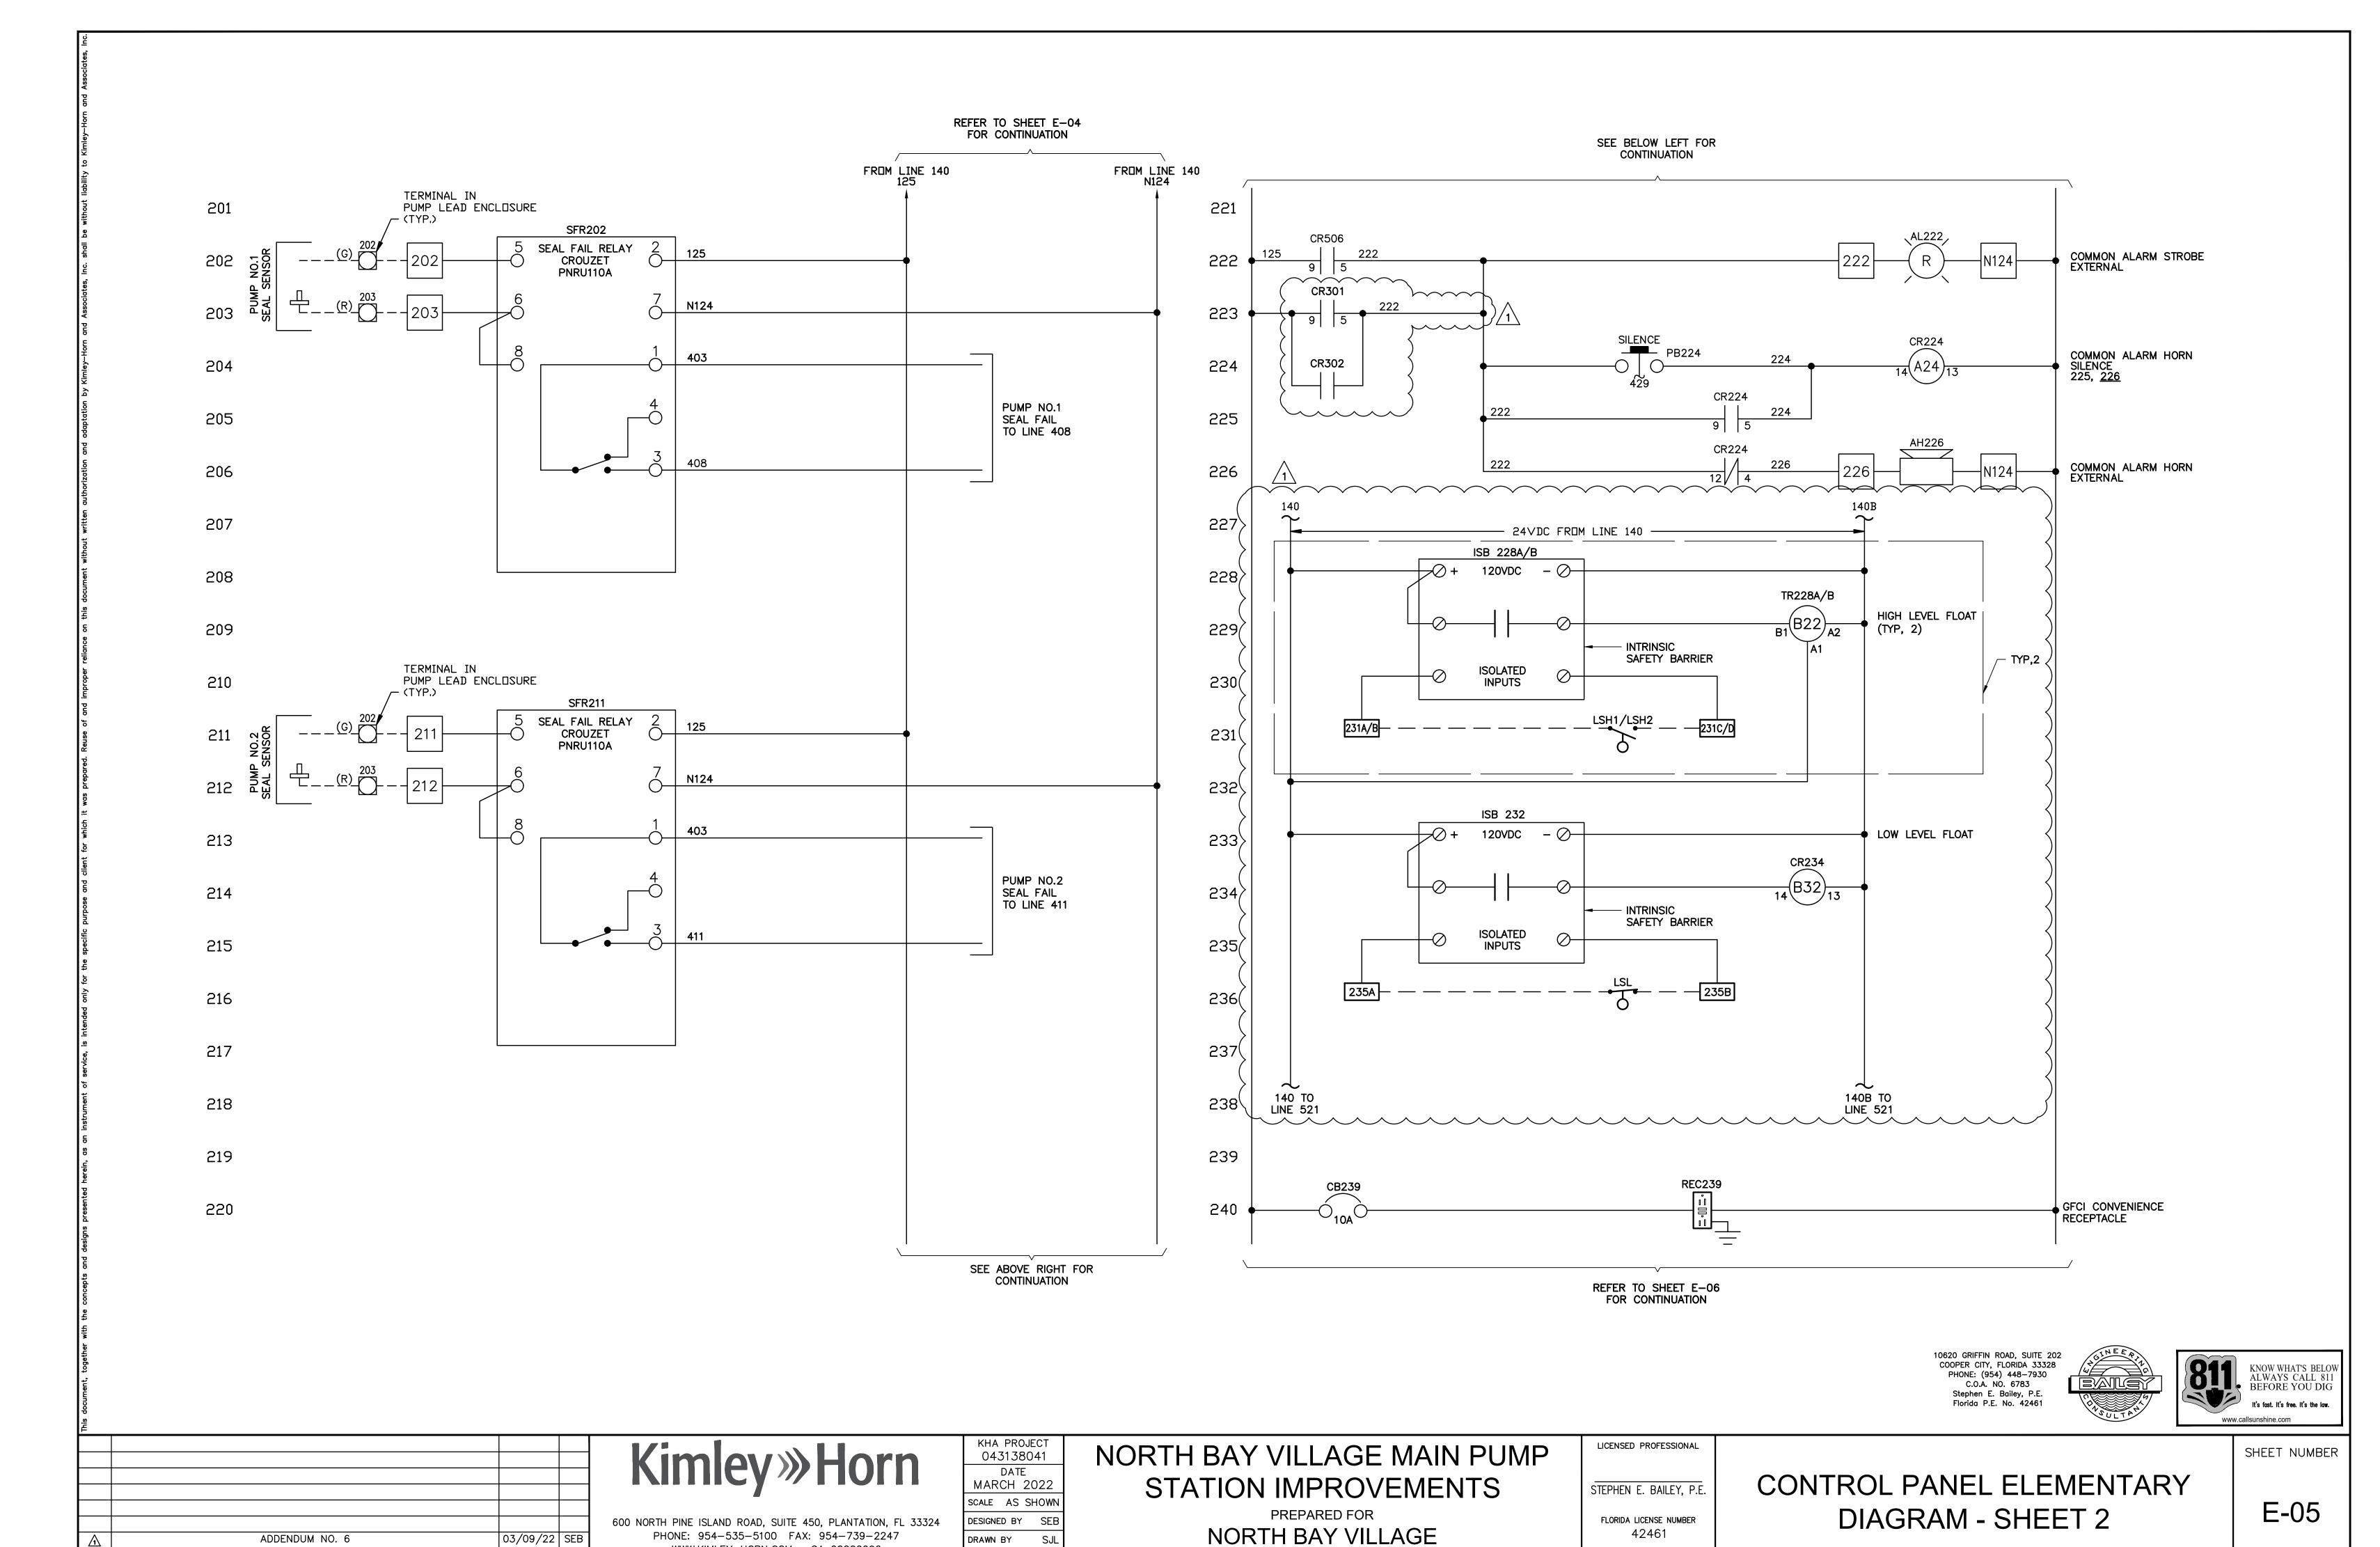E-08

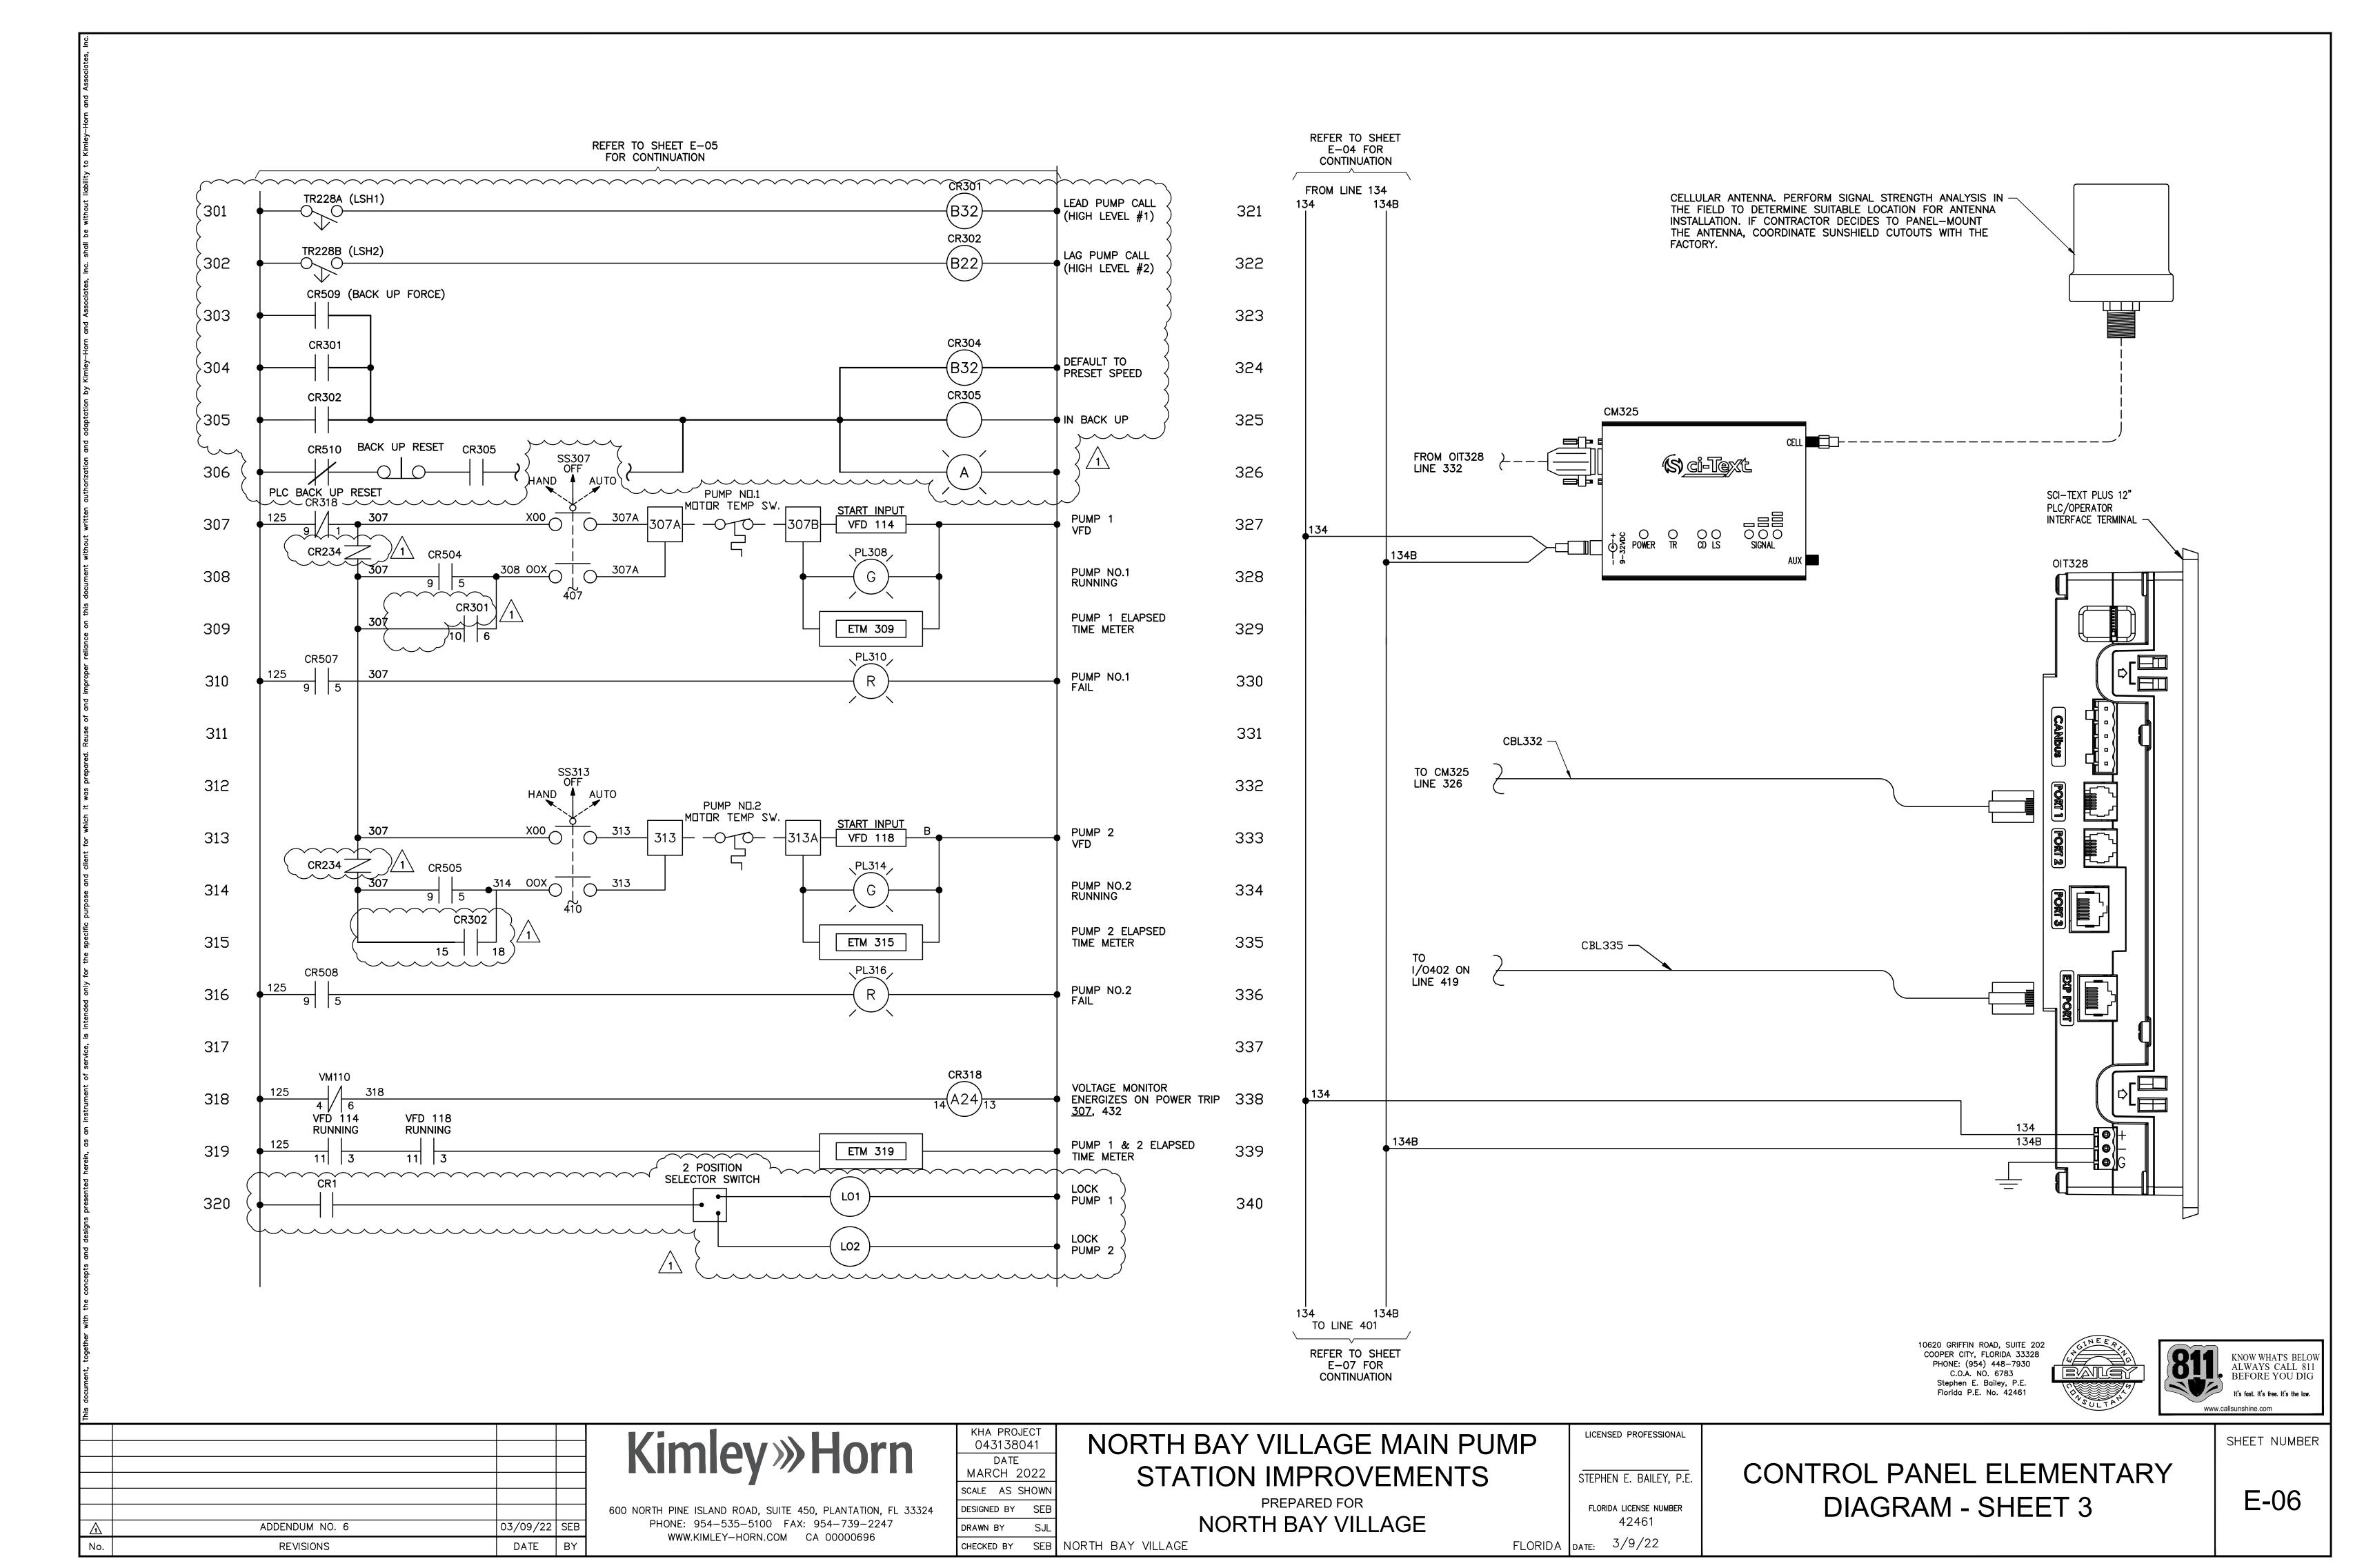

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